RH - PALM DESERT GALLERY

73100 El Paseo, Suites 3-10 Palm Desert, CA 92260

01/31/2025 PLANNING RESUBMISSION



GENERAL NOTES

- 1. THE EXISTING CONDITIONS IN THE CONSTRUCTION DOCUMENTS ARE BASED ON PDF FILES PROVIDED BY THE OWNER AND SURVEY DATED: 10/15/2024 AND PREPARED BY: FOUST ARCHITECTURE, INC; ANY DISCREPANCIES BETWEEN THESE DOCUMENTS AND THE ACTUAL FIELD CONDITIONS SHALL BE BROUGHT TO THE ATTENTION OF THE ARCHITECT BEFORE PROCEEDING WITH ANY WORK.
- 2. THE CONTRACTOR SHALL REVIEW ALL DOCUMENTS AND VERIFY ALL DIMENSIONS AND FIELD CONDITIONS AND SHALL CONFIRM THAT WORK IS BUILDABLE AS SHOWN. ANY CONFLICTS OR OMISSIONS, ETC., SHALL BE IMMEDIATELY REPORTED TO THE ARCHITECT IN WRITING FOR CLARIFICATION PRIOR TO THE PERFORMANCE OF ANY WORK IN QUESTION
- 3. THE CONTRACTOR SHALL COORDINATE ALL TRADES, UTILITIES, AND ARCHITECTURAL PLANS WITH ALL ENGINEERING PLANS. NOTIFY ARCHITECT OF ANY AND ALL DISCREPANCIES IMMEDIATELY IN WRITING.
- ALL WORK AND MATERIAL SHALL BE EXECUTED IN FULL ACCORDANCE WITH ALL APPLICABLE CODES.
- 5. ALL MATERIAL UNDER THIS CONTRACT SHALL BE NEW UNLESS OTHERWISE NOTED.
- 6. GENERAL CONTRACTOR SHALL PROVIDE AND BE RESPONSIBLE FOR ALL COSTS FOR PUBLIC PROTECTION AS REQUIRED BY THE CONTRACT DOCUMENTS AND LOCAL GOVERNMENT AGENCIES.
- 7. GENERAL CONTRACTOR SHALL MAKE NO REVISIONS, ALTERATIONS OR CHANGES TO THE WORK AS SHOWN IN THE CONTRACT DOCUMENTS WITHOUT THE PRIOR WRITTEN APPROVAL OF THE ARCHITECT AND/OR OWNERS REPRESENTATIVE. NO ADDITIONAL COSTS FROM THE GENERAL CONTRACTOR SHALL BE CONSIDERED AND THE WORK MAY BE REQUIRED TO BE REMOVED WITHOUT SUCH APPROVAL BY ARCHITECT.
- 8. GENERAL CONTRACTOR SHALL PROVIDE THE BUILDING OFFICIAL WITH A CERTIFICATE OF CONSTRUCTION COMPLIANCE WITH ENERGY CONSERVATION STANDARDS UPON FINAL BUILDING DEPARTMENT INSPECTIONS (WHERE REQUIRED).
- 9. WHEN CONTRACTOR ACCEPTS DELIVERY OF ITEMS NOTED ON PLANS WHETHER IN CONTRACT OR NOT IN CONTRACT, THE CONTRACTOR SHALL BE RESPONSIBLE FOR LOSS OF AND/OR DAMAGE TO THESE ITEMS.
- 10. THE CONTRACTOR SHALL MAINTAIN FOR THE ENTIRE DURATION OF THE WORK ALL EMERGENCY EXITS, EXIT LIGHTING, FIRE PROTECTION DEVICES AND ALARMS IN CONFORMANCE WITH ALL APPLICABLE CODES AND ORDINANCES.
- 11. 'TYP.' SHALL MEAN THAT THE CONDITION IS REPRESENTATIVE FOR SIMILAR CONDITIONS THROUGHOUT, UNLESS OTHERWISE NOTED.
- 12. ALL DETAILS, SECTIONS, AND NOTES SHOWN ON THE DRAWINGS ARE INTENDED TO BE TYPICAL, AND SHALL APPLY TO SIMILAR SITUATIONS ELSEWHERE UNLESS OTHERWISE NOTED. THE DETAILS ON THE DRAWINGS SHALL BE USED WHEREVER APPLICABLE, UNLESS OTHERWISE NOTED. NOTES AND DETAILS ON THE DRAWINGS SHALL TAKE PRECEDENCE OVER GENERAL NOTES AND TYPICAL DETAILS.
- 13. OBSERVATION VISITS TO THE JOB SITE BY THE ARCHITECT'S AND ENGINEER'S FIELD REPRESENTATIVES SHALL NEITHER BE CONSTRUED AS INSPECTION NOR APPROVAL OF CONSTRUCTION.
- 14. DO NOT SCALE DRAWINGS. WRITTEN DIMENSIONS GOVERN ALL PARTITION LOCATIONS. ALL DOOR AND OPENING LOCATIONS SHALL AS BE SHOWN ON FLOOR PLAN. IN CASE OF CONFLICT, NOTIFY THE ARCHITECT. LOCATIONS NOTED ON ARCHITECTURAL PLANS SUPERSEDE LOCATIONS SHOWN ON OTHER CONSULTANT DRAWINGS. ALL DIMENSIONS MARKED "CLEAR" SHALL BE MAINTAINED AND SHALL ALLOW FOR THICKNESS OF ALL FINISHES INCLUDING CARPET, PAD, CERAMIC TILE, V.C.T., ETC.

- 15. CONTRACTOR SHALL MARK LOCATIONS OF PARTITIONS AND DOORS FOR REVIEW BY THE OWNER'S REPRESENTATIVE PRIOR TO INSTALLATION. R REVIEW WILL BE FOR DESIGN INTENT. SUBCONTRACTOR SHALL COORDINATE AND VERIFY ALL CONDITIONS TO ENSURE PROPER FIT.
- 16. COLUMN CENTER LINE (OR GRID LINES) ARE SHOWN FOR DIMENSIONING. VERIFY EXACT LOCATIONS IN FIELD.
- 17. CONTRACTOR TO VERIFY INTEGRITY OF EXISTING CONDITIONS, INCLUDING ALL STRUCTURAL ELEMENTS, AFTER COMPLETION OF DEMOLITION AND NOTIFY THE OWNER'S AND LANDLORDS REPRESENTATIVE IMMEDIATELY OF ANY DAMAGES AND/OR INSTABILITY.
- 18. SAFETY MEASURES: AT ALL TIMES THE CONTRACTOR SHALL BE SOLELY AND COMPLETELY RESPONSIBLE FOR THE CONDITIONS OF THE JOB SITE, INCLUDING SAFETY OF THE PERSONS & PROPERTY AND FOR ALL INDEPENDENT ENGINEERING REVIEWS OF THESE CONDITIONS. THE ARCHITECT'S OR ENGINEER'S JOB SITE REVIEW IS NOT INTENDED TO INCLUDE REVIEW OF THE ADEQUACY OF THE CONTRACTOR'S SAFETY
- 19. UTILITY SERVICES: CONTRACTOR AND HIS SUBCONTRACTORS SHALL CONFIRM LOCATIONS OF ALL UTILITIES AND NOTIFY ALL PERSONS WORKING ON THE SITE OF EXISTING UTILITIES. CONTRACTOR SHALL LOCATE AND IDENTIFY ACTIVE UTILITY SERVICE AND TEMPORARILY DEACTIVATE THEN WHEN THEY CONSTITUTE A HAZARD. LOCATION OF GAS, ELECTRIC, AND WATER METERS TO CONFORM TO UTILITY COMPANY REQUIREMENTS.
- 20. PROTECT THE EXISTING CONSTRUCTION FINISHES, ADJACENT PROPERTY, PLANTINGS AND TREES. PROTECT THE WORK FROM RAIN AND OTHER NATURAL ELEMENTS. REPAIR, REFINISH, OR REPLACE ANY ITEMS DAMAGED DURING CONSTRUCTION.

PARCEL MAP

P. M. 59/31.32 Percel Map 13,593 P. M. 59/90,91

PERMITS

DEFFERED APPROVAL PERMITS

FIRE SPRINKLER SYSTEM: IS NOT WITHIN THE SCOPE OF THIS PERMIT. SUBMIT DRAWINGS TO LOCAL JURISDICTION FOR REVIEW AND APPROVAL IN ACCORDANCE WITH LOCAL CODES AND ORDINANCES PRIOR TO INSTALLATION.

FIRE ALARM: IS NOT WITHIN THE SCOPE OF THIS PERMIT. SUBMIT DRAWINGS TO LOCAL JURISDICTION FOR REVIEW AND APPROVAL IN ACCORDANCE WITH LOCAL CODES AND ORDINANCES PRIOR TO INSTALLATION.


EXTERIOR SIGNAGE: IS NOT WITHIN THE SCOPE OF THIS PERMIT. SUBMIT DRAWINGS TO LOCAL JURISDICTION FOR REVIEW AND APPROVAL IN ACCORDANCE WITH LOCAL CODES AND ORDINANCES PRIOR TO INSTALLATION.

SITE MAP



REMODELING SCOPE

VICINITY MAP

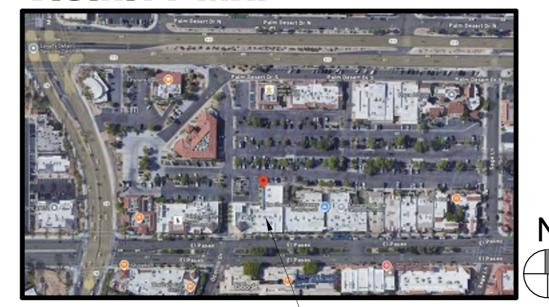

PROJECT LOCATION, SEE SITE MAP-73100 El Paseo Drive Palm Desert, CA

PROJECT DIRECTORY

TENANT:
Restoration Hardware
15 Koch Rd
Corte Madera, Ca 94925
T: 415.996.4714
Contact: Michael Resneck
Email: mresneck@rh.com

ARCHITECT:
Foust Architecture, Inc.
330 Capistrano Ave,
San Francisco, CA 94112
T: 415.655.3347
Contact: Brian Foust
E-mail: brian@foustarchitecture.com

LIGHTING DESIGNER:
RKV Design
5870 Melrose Ave, Suite 3, #311
Los Angelis Ca, 90038
T: 310.924.2185
Contact: Rebecca Hidalgo
E-mail: rebecca@rkv-design.com

OWNER:
El Paseo Collection North. LLP 73-061
El Paseo, Suite 200
Palm Desert, CA 92260
T: 706.341.4888
Contact: David Fletcher
E-mail: dfletcher@chartwellproperties.net

MEP ENGINER:
MEECI, INC
14496 N. SHELDON RD. STE 260
Plymouth, MI, 48170
T: 734.454.5516
Contact: Jordan Koenig
E-mail: jkoeing@meeci.com

CONTRACTOR:
TBD:
T:
Contact:
E-mail:

PALM DESERT MUNICIPAL CODE REQUIREMENTS

Palm Desert Municipal Code requirements:

A. Approved temporary sanitary facilities are required (H&S 5416).
B. Contractor and/or owner shall provide a trash bin (PDMC 8.16).
C. Building Materials or Debris Storage shall be on the property of the permit. (PDMC 8.70).
D. The public right-of-way shall always be maintained in a clean condition. (PDMC 8.20).
E. Address numerals shall comply with PDMC 15.28.

F. Each general engineering contractor, general building contractor, and swimming pool contractor shall furnish the city with a list of each subcontractor under his control or direction, AND each subcontractor shall have obtained a business license before the inal inspection of a building or structure shall be given by the building and safety department. (PDMC §5.06.010.).

G. Construction Hours (PDMC 9.24):

OCTOBER 1st THRU APRIL 30th: Monday – Friday: 7:00 a.m. - 5:30 p.m. Saturday - 8:00 a.m. - 5:00 p.m. Sunday - NOT ALLOWED MAY 1st THRU SEPTEMBER 30th: Monday – Friday: 5:30 a.m. - 7:00 p.m. Saturday 8:00 a.m. - 5:00 p.m. Sunday - NOT ALLOWED

- Government Code Holidays - NOT ALLOWED -

**Violation of the above work hours is a citable offense under PDMC 9.24.070.

SCOPE OF WORK

PROJECT CONSISTS OF THE FOLLOWING:

EXTERIOR WORK: - EXISTING FRONT AND REAR STOREFRONT FRAME SYSTEM & WALLS TO BE DEMO & NEW TO BE CONSTRUCT AT SAME LOCATION. NEW PAINTED EXTERIOR WALL FINISH, NEW PAINTED FINISH ON (N) EXTERIOR LIGHTING, EXISTING AWNING TO BE DEMOLISHED AND (N) AWNING, (N) LANDSCAPE & HARDSCAPE TO BE

INTERIOR WORK: - UNDER SEPARATE PERMIT.-

PROVIDED

PROJECT DATA

PARCEL AREA: 33,977 SQ. FT.

ZONING: D - (DOWNTOWN DISTRICT)

OCCUPANCY: M

CONSTRUCTION TYPE: TYPE V

AREA CACULATIONS

GROSS FLOOR AREA: EXISTING

PALM DESERT MUNICIPAL CODE

BUILDING 14,330 SQ.FT. NO CHANGE TO EXISTING SQ.FT. TENANT 10,543 SQ.FT. NO CHANGE TO EXISTING SQ.FT.

APPLICABLE CODES

2022 CALIFORNIA BUILDING CODE (CBC)
2022 CALIFORNIA ELECTRICAL CODE (CEC)
2022 CALIFORNIA MECHANICAL CODE (CMC)
2022 CALIFORNIA PLUMBING CODE (CPC)
2022 CALIFORNIA ENERGY CODE (CENC)
2022 CALIFORNIA FIRE CODE (CFC)
2022 CALIFORNIA GREEN BUILDING STANDARDS CODE (CALGREEN)

Client



Project Title:

RH PALM DESERT GALLERY

73100 El Paseo, Suites 3-10 Palm Desert CA, 92260 APN 627-192-014

Architect:



4804 Mission St.
San Francisco, CA 94114
brian@foustarchitecture.com
T: 857.574.0010

Stamps



Agency Approvals:

No	Issue Description	Date
	PLANNING SUBMITTAL	12/20/202
1	PLANNING RE-SUBMITTAL	01/31/202

Author:

C.G.

Date:

08/28/2024

Project No.

2405

Scale:

As Indicated

COVER SHEET

Sheet Title:

APO 0

ABBREVIATIONS

ABV AFF ABOVE FINISH FLOOR AL, ALUM ALUMINUM ANOD ANODIZED ARCH **ARCHITECT** BD BOARD BDRM **BEDROOM** BLDG BUILDING **BLOCKING** BLKG BLW **BELOW** BTWN BETWEEN **BOTTOM OF** ВО BOH CAB CALCS CBC BACK OF HOUSE CABINET CACULATIONS CALIFORNIA BUILDING CODE CENTERLINE CL CLG CEILING CH **CEILING HEIGHT** CLR CLEAR COL COLUMN CONC CONCRETE CONSTR CONSTRUCTION CONT CONTINUOUS COORD COORDINATE C/C CENTER TO CENTER DF DOUGLAS FIR DIAMETER DIA DIM DIMENSION EΑ EACH **ELEVATION** ELEV EQ **EQUAL**

EXISTING

EXTERIOR

FLOOR DRAIN

FINISH FLOOR

FLUORESCENT

FINISHED OPENING

GYPSUM BOARD

FIRE RESISTIVE TREATED

GENERAL CONTRACTOR

HEATING, VENTILATION,

AIR CONDITIONING INTERIOR DESIGNER

INCANDESCENT

INCLUDED

INTERIOR LEVEL

FIXTURE

MAXIMUM

MINIMUM

METAL

MECHANICAL MANUFACTURER

MISCELLANEOUS

UTILITY METER

NOT APPLICABLE NOT IN CONTRACT NOT SPECIFIED

NOT TO SCALE

PLYWOOD PREFINISHED

REGULATIONS

ROUGH OPENING

SOUND TRANSMISSION

REFERENCE

SOLID CORE

COEFFICIENT SQUARE SQUARE FEET

STEEL STRUCTURE

TEMPERATURE

TEMPERED GLASS

VOLUME CONTROL

WATER CLOSET

WALL OPENING

UNLESS OTHERWISE NOTED

TRANSOM

THROUGH TOP OF

TYPICAL

VERTICAL VERTICAL GRAIN VERIFY IN FIELD

WITHOUT WOOD

REQUIRED

SECTION

SHEET

SHOWER

SIMILAR

PROJECT MANAGER

PRESSURE TREATED

REFLECTED CEILING PLAN

ON CENTER OPENING

PAINT

PLATE **PLEXIGLASS**

RADIUS

GALVANIZED SHEET METAL

HIGH DENSITY FIBERBOARD

LIGHT EMITTING DIODE LIGHT

MEDIUM DENSITY FIBERBOARD

FLOORING

FRAMING

GLASS

HEIGHT

HOUR

HORIZONTAL **HOLLOW METAL**

FD FLG FLUOR FO FRMG FRF GC GL GSM GYP BD HDF HT HORIZ HM HR HVAC INCAND INCL INT LED MAX

(E) ÈΧΤ

MDF MECH MFG MISC MIN MTL MTR NIC NS NTS OC OPNG PL PLEX PLYWD PREFIN PM PT RAD RCP REGS REF REQD RO SC SECT SHT SHWR SIM STC STL STRUCT TRAN TEMP TEMP GL TEMP G THRU TO TYP UON VCB VERT VG

VIF

W/ WC WO W/O WD

SYMBOL LEGEND

____LEVEL ____

SECTION DESIGNATION **BUILDING SECTION MARK** SHEET NUMBER WHERE

SECTION APPREARS

ELEVATION MARK

GRID LINE

 $\begin{pmatrix} 1 \\ A3.01 \end{pmatrix}$

EXTERIOR ELEVATION MARK



NORTH ARROW




ROOM NAME/NUMBER



WINDOW TYPE SYMBOL -REF. WINDOW SCHEDULE

DOOR TAG

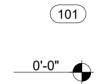

FLOOR ELEVATION TAG



SPOT ELEVATION TAG



LINEAR LIGHT FIXTURE

CASEWORK LIGHT FIXTURE



FAN COIL UNIT - HVAC



ACCESS PANEL



SUPPLY DIFFUSER



EXHAUST



DECORATIVE CHANDELIER LIGHT FIXTURE SPOT LIGHT FIXTURE



STROBE SPEAKER



CCTV - CAMERA



WAP - WIRELESS ACCESS POINT

EM - EMEGENCY LIGHT



AUDIO SPEAKER



FIRE SPRINKLER



NOT IN CONTRACT



NORTH MARK

SHEET INDEX

	SHEET#	SHEET TITLE	PLANNING SET	PLANNING REV
	ARCHITEC	TURAL		
	AP0.0	COVER SHEET	X	Χ
	AP0.0a	SHEET INDEX, SYMBOLS, LEGENDS & ABBREVIATIONS	X	Χ
	AP0.0b	CODE ANALYSIS	X	Χ
	AP0.1	RENDERINGS	X >	Χ
	AP0.2	RENDERINGS	X >	Χ
	AP1.0	SITE PLAN - DEMO	X	Χ
	AP1.1	SITE PLAN - PROPOSED	X	Χ
	AP2.0	FLOOR PLAN - DEMO	X	Χ
	AP2.1	FLOOR PLAN - PROPOSED	X	Χ
	AP2.2	ENLARGED FLOOR PLAN - PROPOSED	X >	Χ
	AP3.0	ROOF PLAN - DEMO	X	Χ
	AP3.1	ROOF PLAN - PROPOSED	X	Χ
	AP4.0	EXTERIOR ELEVATIONS	X	Χ
	AP4.1	EXTERIOR ELEVATIONS	X	Χ
	AP4.2	EXTERIOR ELEVATIONS	X >	Χ
	AP4.3	EXTERIOR ELEVATIONS	X >	Χ
	AP4.4	STOREFRONT SECTION / ELEVATION	X >	Χ
~~	AP4.5	EXTERIOR BLDG. SITE PHOTOS & RENDERINGS - EXISTING & PROPOSED	X	Х
}	AP4.6	BUILDING SECTION		Χ
	m		my	
	LANDSCAF	PE		
	L1.1	PRELIMINARY LANDSCAPE PLAN	X (Χ
	L1.2	PRELIMINARY HARDSCAPE PLAN	X {	Χ
	LIGHTING			
	LT-1.0	EXTERIOR LIGHTING PLAN	X >	Χ

Client:



Project Title:

RH PALM DESERT GALLERY

73100 El Paseo, Suites 3-10 Palm Desert CA, 92260 APN 627-192-014

Architect:



FOUST ARCHITECTURE 4804 Mission St. San Francisco, CA 94114 brian@foustarchitecture.com T: 857.574.0010

Stamps:



08/28/2024

As Indicated

2405

Agency Approvals:

No	Issue Description	Date
	PLANNING SUBMITTAL	12/20/2024
1	PLANNING RE-SUBMITTAL	01/31/2025
Author:		
		C.G
Date:		


SHEET INDEX, SYMBOLS, LEGENDS & ABBREVIATIONS

Project No.

Sheet Title:

Scale:

AP0.0a

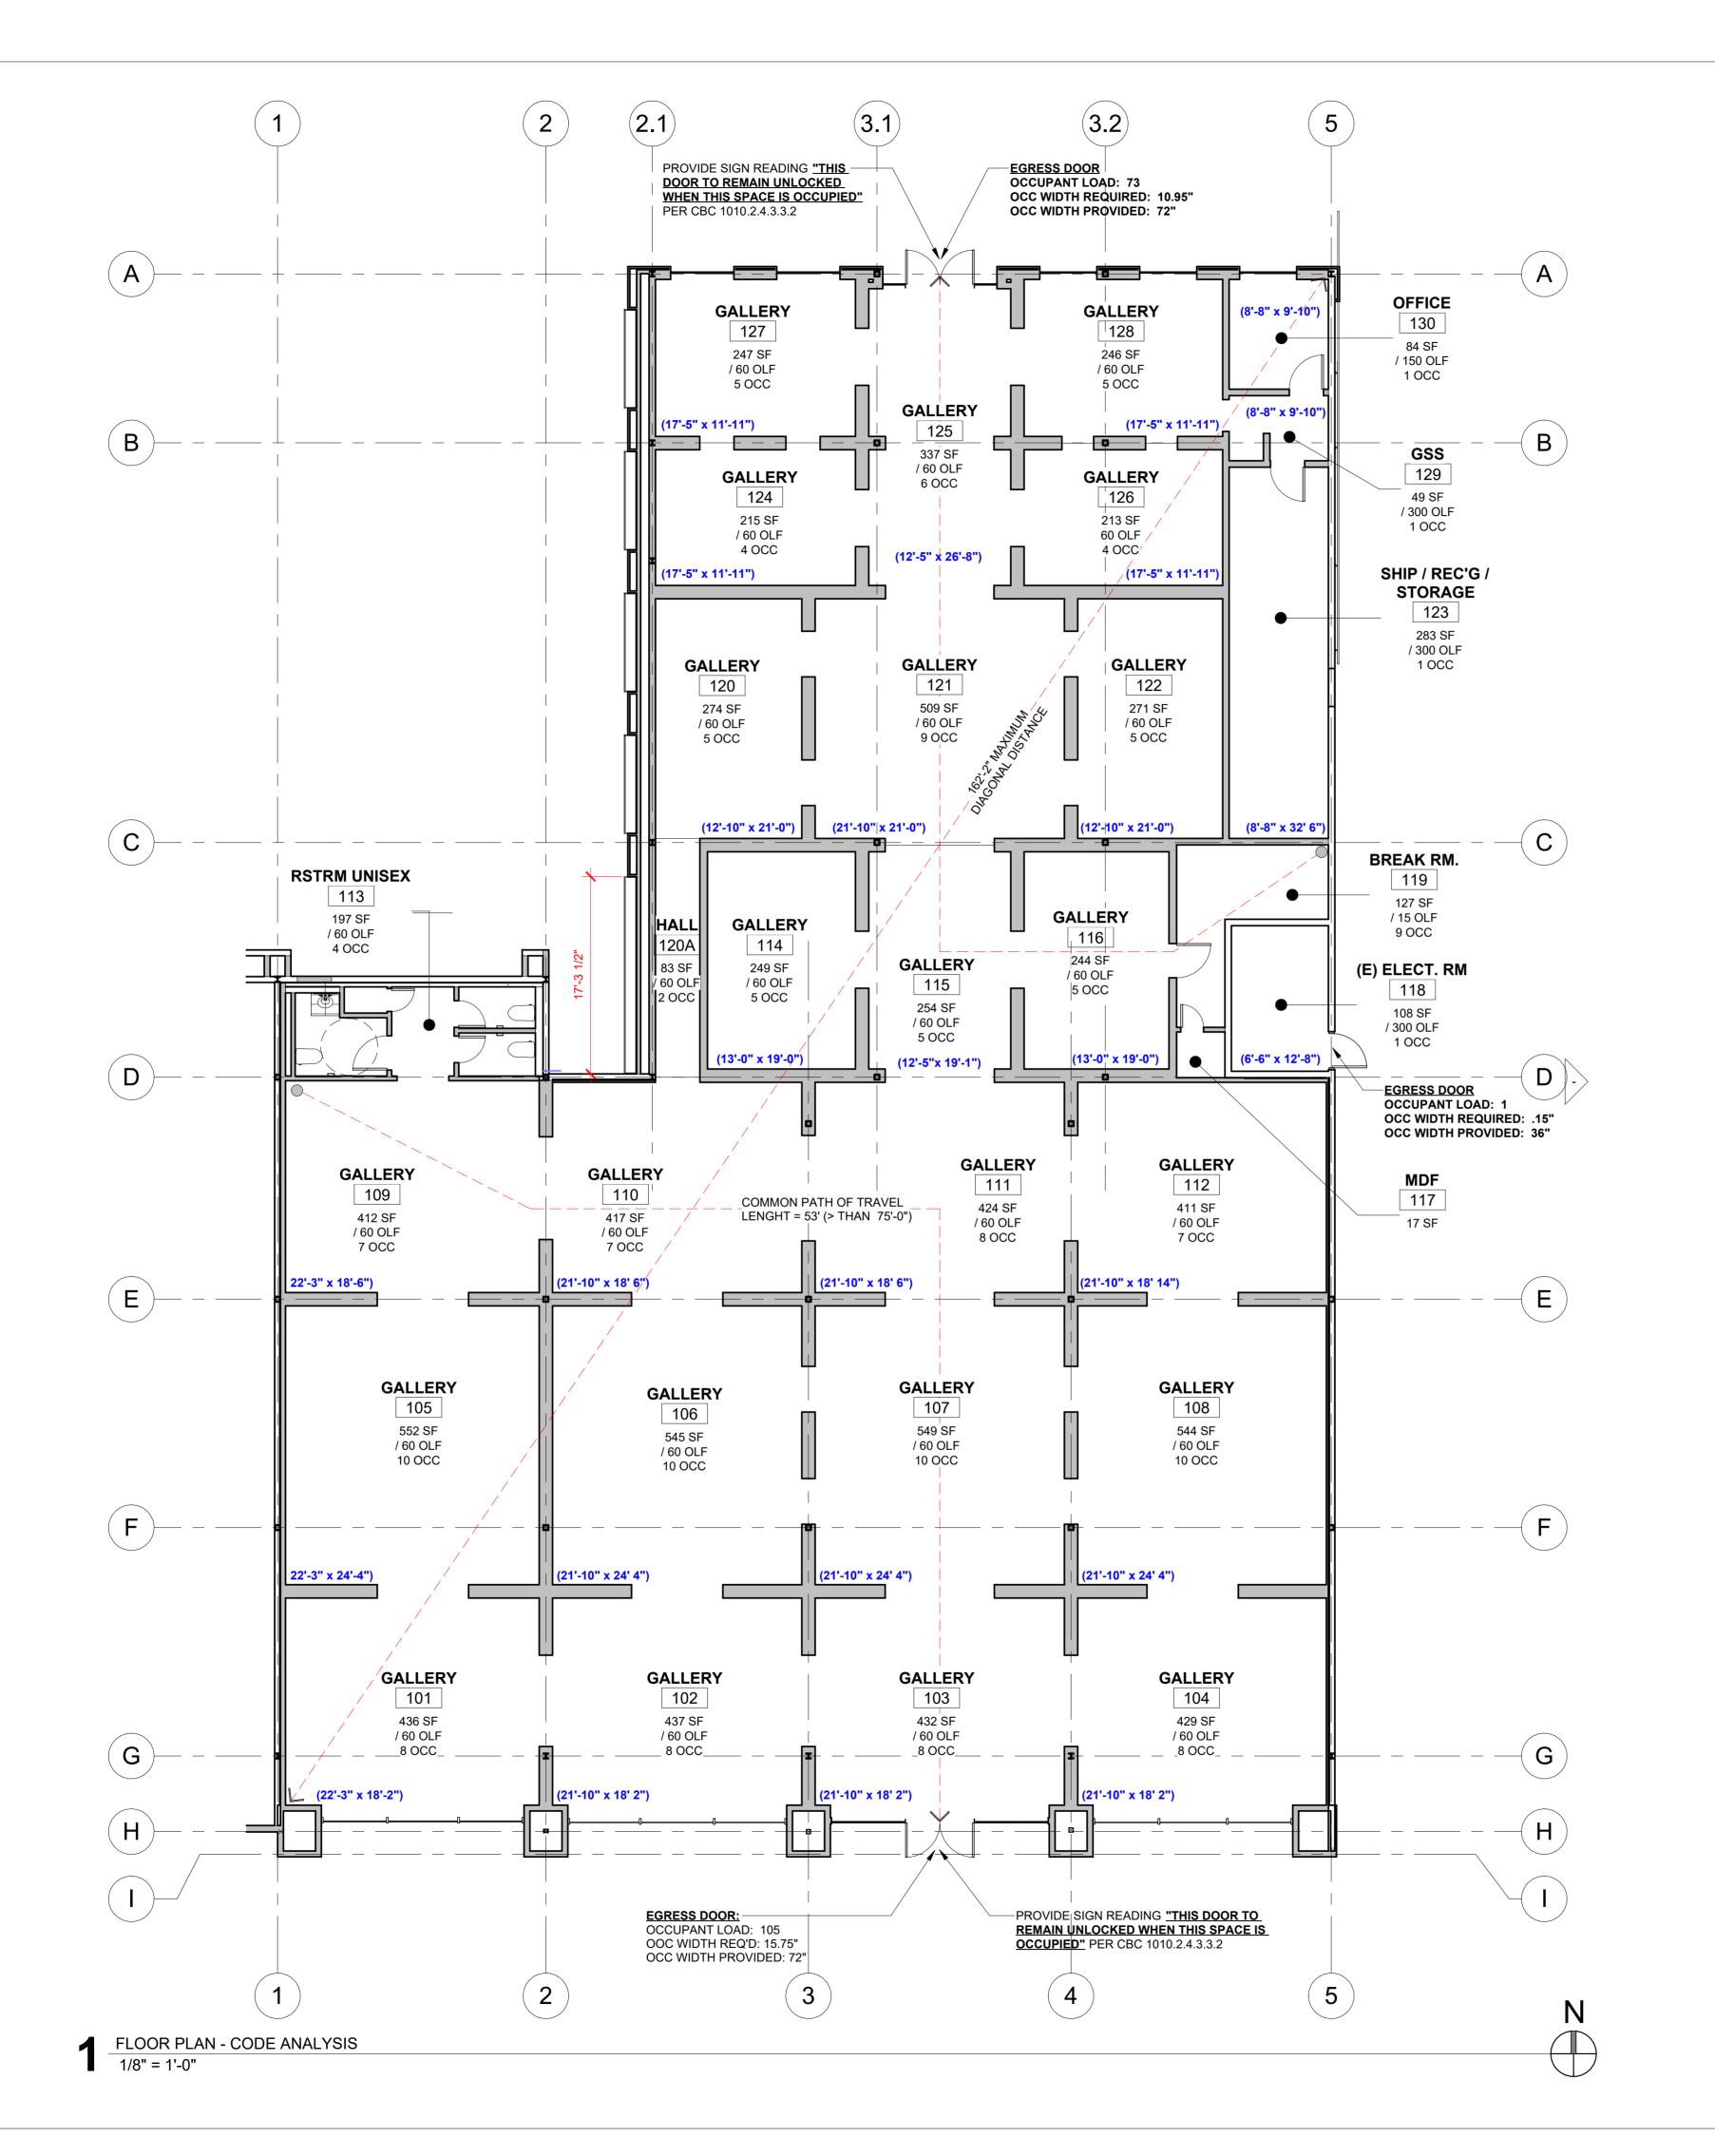

BUILDING CODE ANALYSIS:

THIS ANALYSIS IS A SUMMARY BASED ON THE APPLICABLE FEATURES OF THE 2022 TITLE 24, CALIFORNIA CODE OF REGULATIONS, CALIFORNIA BUILDING CODE AND ANY LOCAL AMENDMENTS. THE FOLLOWING INFORMATION INCLUDES REFERENCES TO PORTIONS OF THE CODE WHICH AFFECT THE DESIGN OF THE PROJECT. THE ARTICLES, SECTIONS, PARAGRAPHS AND TABLES WHICH ARE QUOTED/PARAPHRASED ARE NOT NECESSARILY PRESENTED IN THEIR ENTIRETY. SEE THE CODE FOR FURTHER REQUIREMENTS AND ELABORATIONS. SEE COVER SHEET A0.0 FOR GENERAL BUILDING DESCRIPTION.

CHAPTER 3 - USE AND OCCUPANCY CLASSIFICATION

CONSTRUCTION TYPE V SECTION 602.5
PRIMARY USE GROUP M SECTION 309
GROSS SQ.FT. 10,543 SQ. FT.
T.I. SCOPE SQ.FT. 10,543 SQ. FT.
SPRINKLER SYSTEM YES (NEW PROPOSED)

CHAPTER 5 - GENERAL BUILDING HEIGHTS AND AREAS

ALLOWABLE BLDG. AREA
ALLOWABLE BLDG. HEIGHT
ALLOWABLE BLDG. STORES/AREA
PROPOSED BLDG. AREA
PROPOSED BLDG. AREA
BBOOOSED BLDG. HEIGHT
BROOOSED BLDG. HEIGHT
M 10,543 SQ. FT.
BROOOSED BLDG. HEIGHT
M 123.0" A F F AT HIGHT BOINT

PROPOSED BLDG. HEIGHT M +23-0" A.F.F. AT HIGHT POINT PROPOSED BLDG. STORIES M 1 STORY

CHAPTER 6 - TYPES OF CONSTRUCTION

BUILDING ELEMENT REQ. FIRE RATING (HOURS) SECTION 602

STRUCTURAL FRAME	0	TABLE 601
BEARING WALLS - EXT	0	TABLE 601
BEARING WALLS - INT	0	TABLE 601
NON BEARING WALLS	0	TABLE 601
FLOOR CONSTRUCTION	0	TABLE 601
ROOF CONSTRUCTION	0	TABLE 601
EXT. WALLS <5' SEPARATION	2	TABLE 602
EXT. WALLS <10' SEPARATION	1	TABLE 602
EXT. WALLS <30' SEPARATION	1	TABLE 602
EXT. WALLS >30' SEPARATION	0	TABLE 602

CHAPTER 10 - MEANS OF EGRESS

USES: GROSS AREA / LOAD FACTOR / OCCUPANTS:

BUSINESS (B):	86 / 150 =	1 OCCUPANTS	TABLE 1004.5
MERCANTILE (M):	8,910 / 60 =	149 OCCUPANTS	TABLE 1004.5
SHIPPING & REC. / EQUIP. RM:	408 / 300 =	2 OCCUPANTS	TABLE 1004.5
BREAK ROOM (ASSEMBLY):	127 / 15 =	9 OCCUPANTS	TABLE 1004.5
TOTAL OCCUPANT LOAD:		161 OCCUPANTS	

TOTAL # OF EXITS REQUIRED: 2 SECTION 1006.3.3 EGRESS WIDTH PER OCC.: .15 x 161 OCC = 24.15" WIDTH REQ'D. w/ SPRKLR. SECTION 1007.3.2 SECTION 1007.3.1 MAY PROCESS AND PROTESTANCE.

MAX. DIAGONAL DISTANCE: 162' 2"
MIN. DIST. BETWEEN EXITS: 162'-2" / 3 = 54'-1"
ACTUAL DIST. BETWEEN EXITS: 135' 7"

EXIT ACCESS TRAVEL DISTANCE: 250'-0" w/ SPRKLR. SECTION 1017.2

CHAPTER 11 - ACCESSIBILITY:

BUILDING AND FACILITIES ARE DESIGNED AND CONSTRUCTED TO BE IN ACCORDANCE WITH CBC CHAPTER 11B. SEE ACCESSIBILITY SHEET FOR DETAIL REQUIREMENTS.

Client:



Project Title:

RH PALM DESERT GALLERY

73100 El Paseo, Suites 3-10 Palm Desert CA, 92260 APN 627-192-014

Architect:



FOUST ARCHITECTURE
4804 Mission St.
San Francisco, CA 94114
brian@foustarchitecture.com
T: 857.574.0010

mne:



Agency Approvals:

No	Issue Description	Date
	PLANNING SUBMITTAL	12/20/2024
Author:		'
		C.G
		<u> </u>

08/28/2024

As Indicated

CODE ANALYSIS

Project No.

Sheet Title:

Scale:

AP0.0b



FRONT BUILDING - DAY



FRONT VIEW - NIGHT

Client:



Project Title:

RH PALM DESERT GALLERY

73100 El Paseo, Suites 3-10 Palm Desert CA, 92260 APN 627-192-014

Architect:



FOUST ARCHITECTURE
4804 Mission St.
San Francisco, CA 94114
brian@foustarchitecture.com
T: 857.574.0010

Stamps:



Agency Approvals:

No	Issue Description	Date
	PLANNING SUBMITTAL	12/20/2024
1	PLANNING RE-SUBMITTAL	01/31/2025
Auth	or:	
		C.G.

08/28/2024

As Indicated

Sheet Title:

RENDERINGS

Project No.

AP0.1



REAR OF BUILDING - DAY



WEST SIDE OF BUILDING - DAY



REAR OF BUILDING - PERSPECTIVE VIEW



REAR ENTRY - SIDE VIEW

Client:



Project Title:

RH PALM DESERT GALLERY

73100 El Paseo, Suites 3-10 Palm Desert CA, 92260 APN 627-192-014

Architect:



FOUST ARCHITECTURE
4804 Mission St.
San Francisco, CA 94114
brian@foustarchitecture.com
T: 857.574.0010

Stamps



Agency Approvals:

No	Issue Description	Date
	PLANNING SUBMITTAL	12/20/2024
1	PLANNING RE-SUBMITTAL	01/31/2025


08/28/2024

As Indicated

RENDERINGS

Sheet Title:

AP0.2

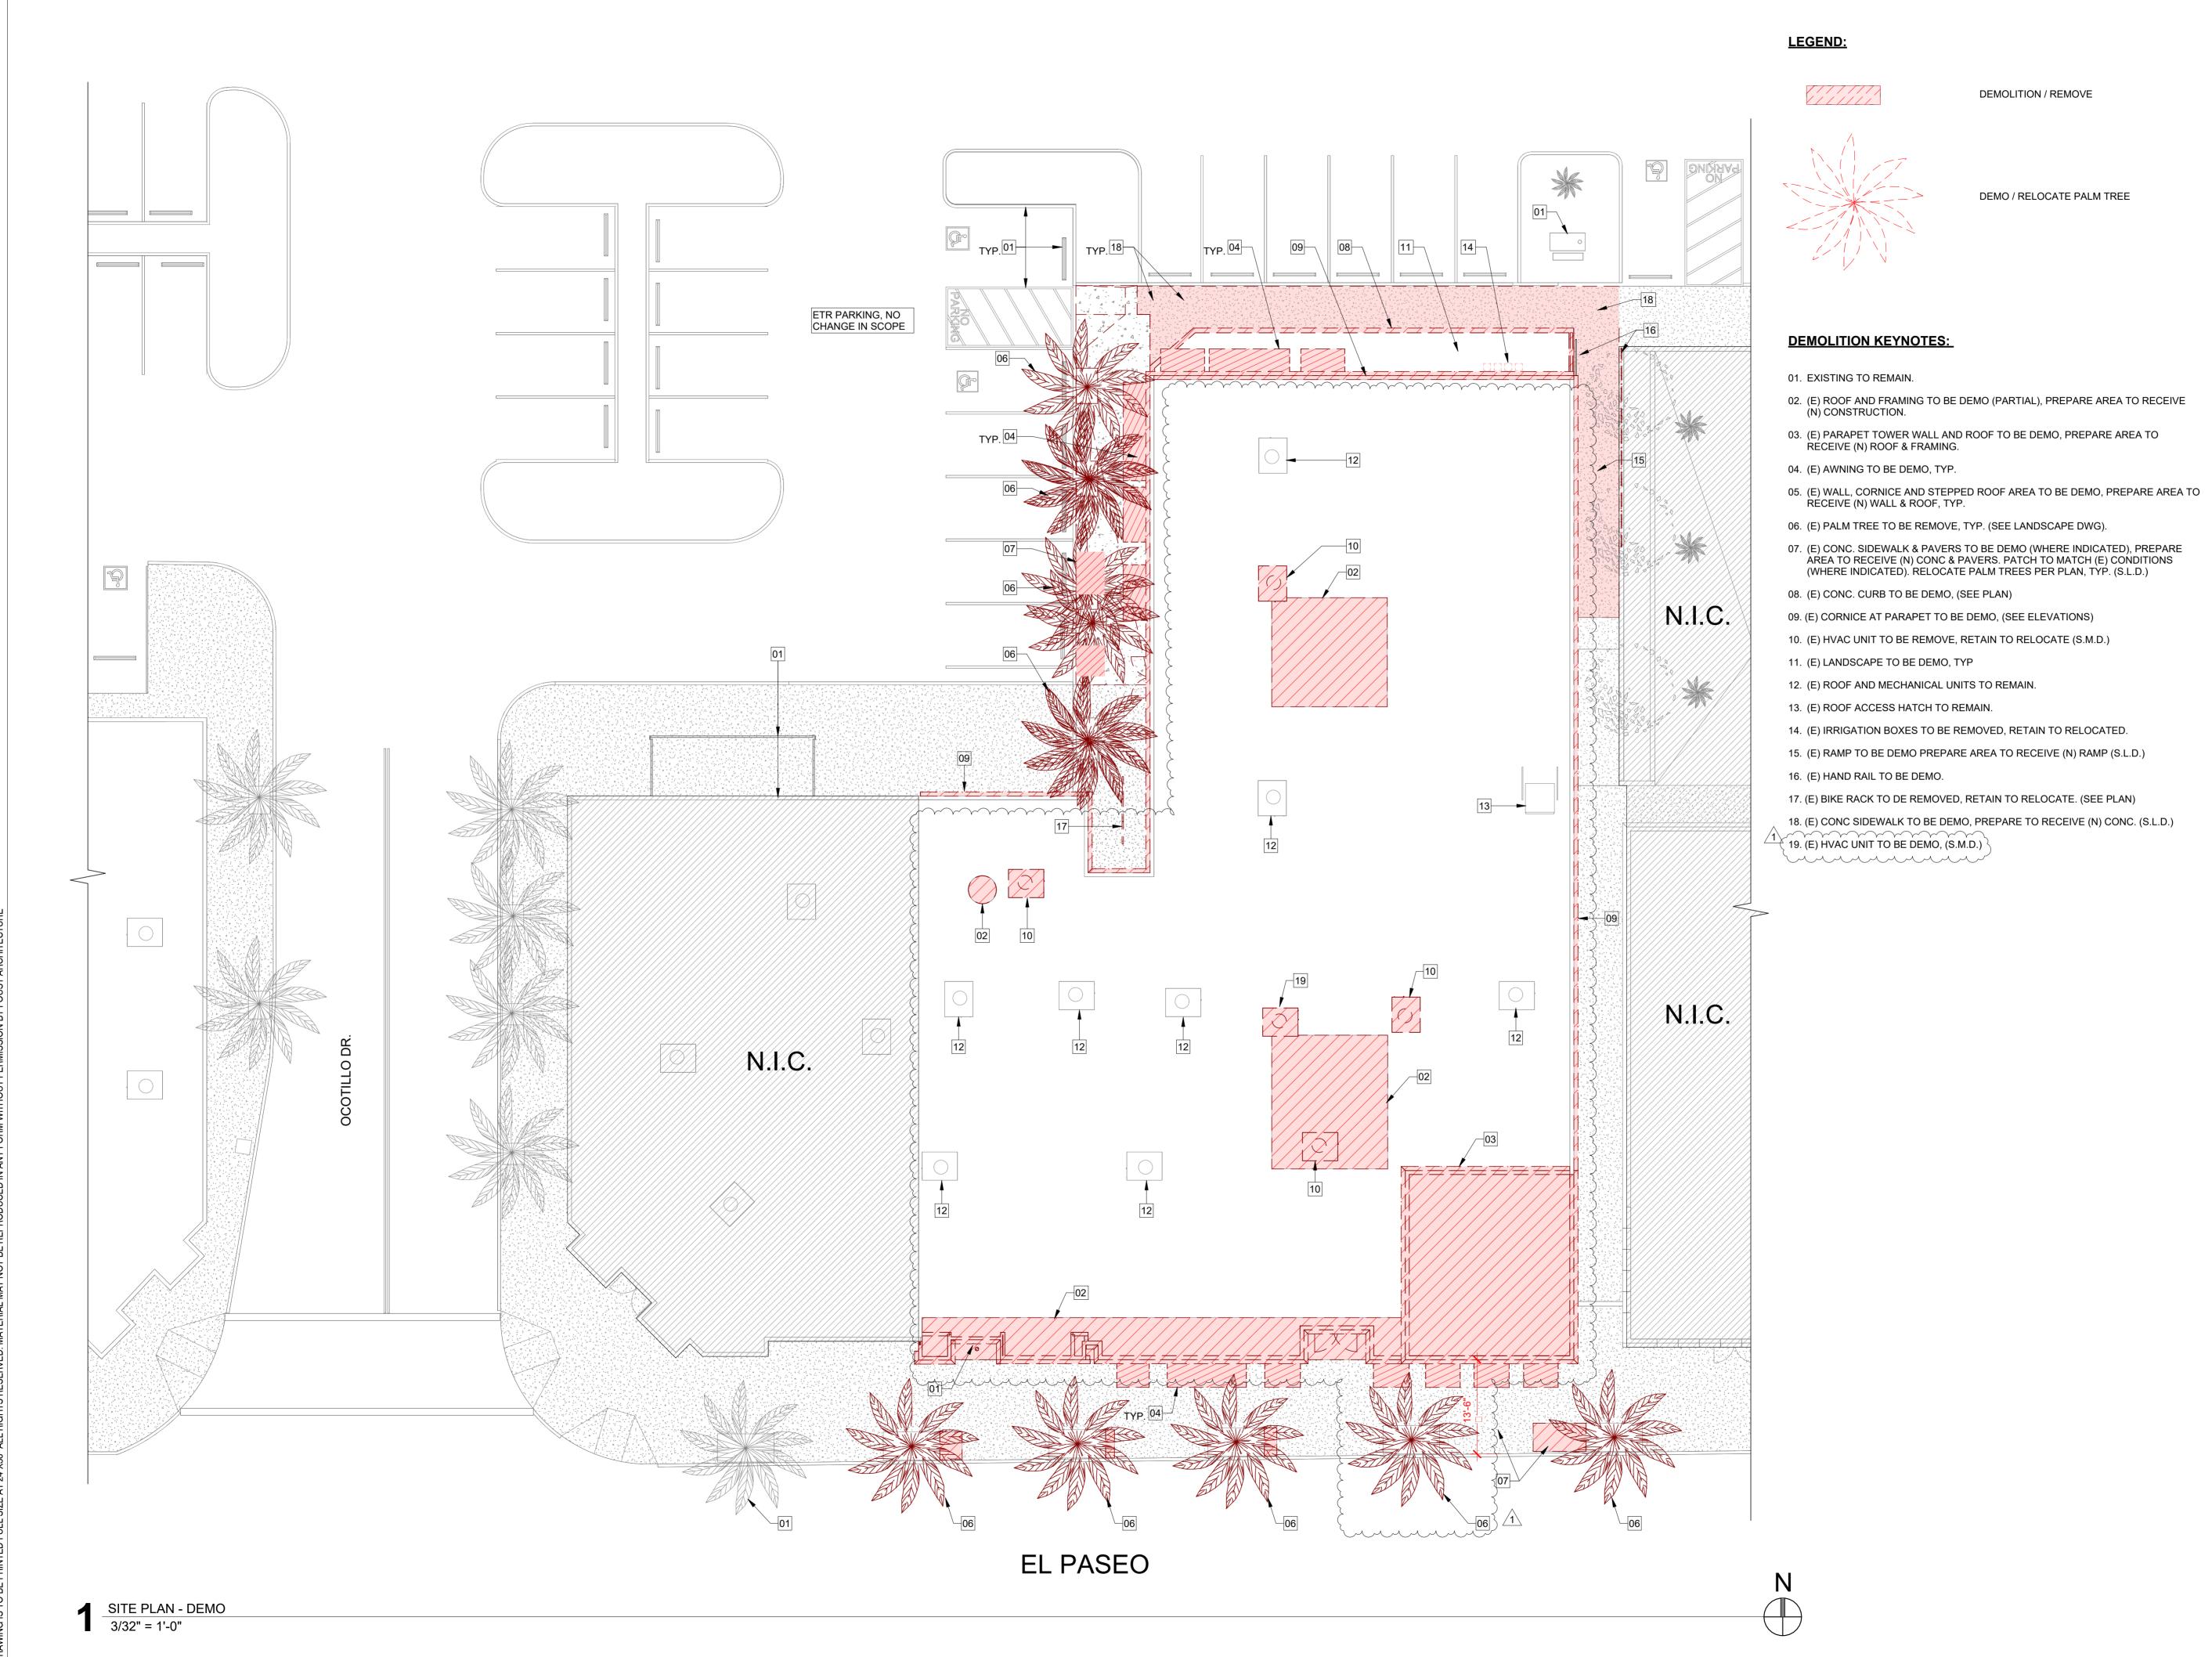

Client:



Project Title:

RH PALM DESERT **GALLERY**

73100 El Paseo, Suites 3-10 Palm Desert CA, 92260 APN 627-192-014

Architect:



FOUST ARCHITECTURE 4804 Mission St. San Francisco, CA 94114 brian@foustarchitecture.com T: 857.574.0010



Agency Approvals:

No	Issue Description	Date
	PLANNING SUBMITTAL	12/20/2024
1	PLANNING RE-SUBMITTAL	01/31/2025
Author	:	
		C.G

08/28/2024


As Indicated

SITE PLAN - DEMO

Project No.

Sheet Title:

AP1.0

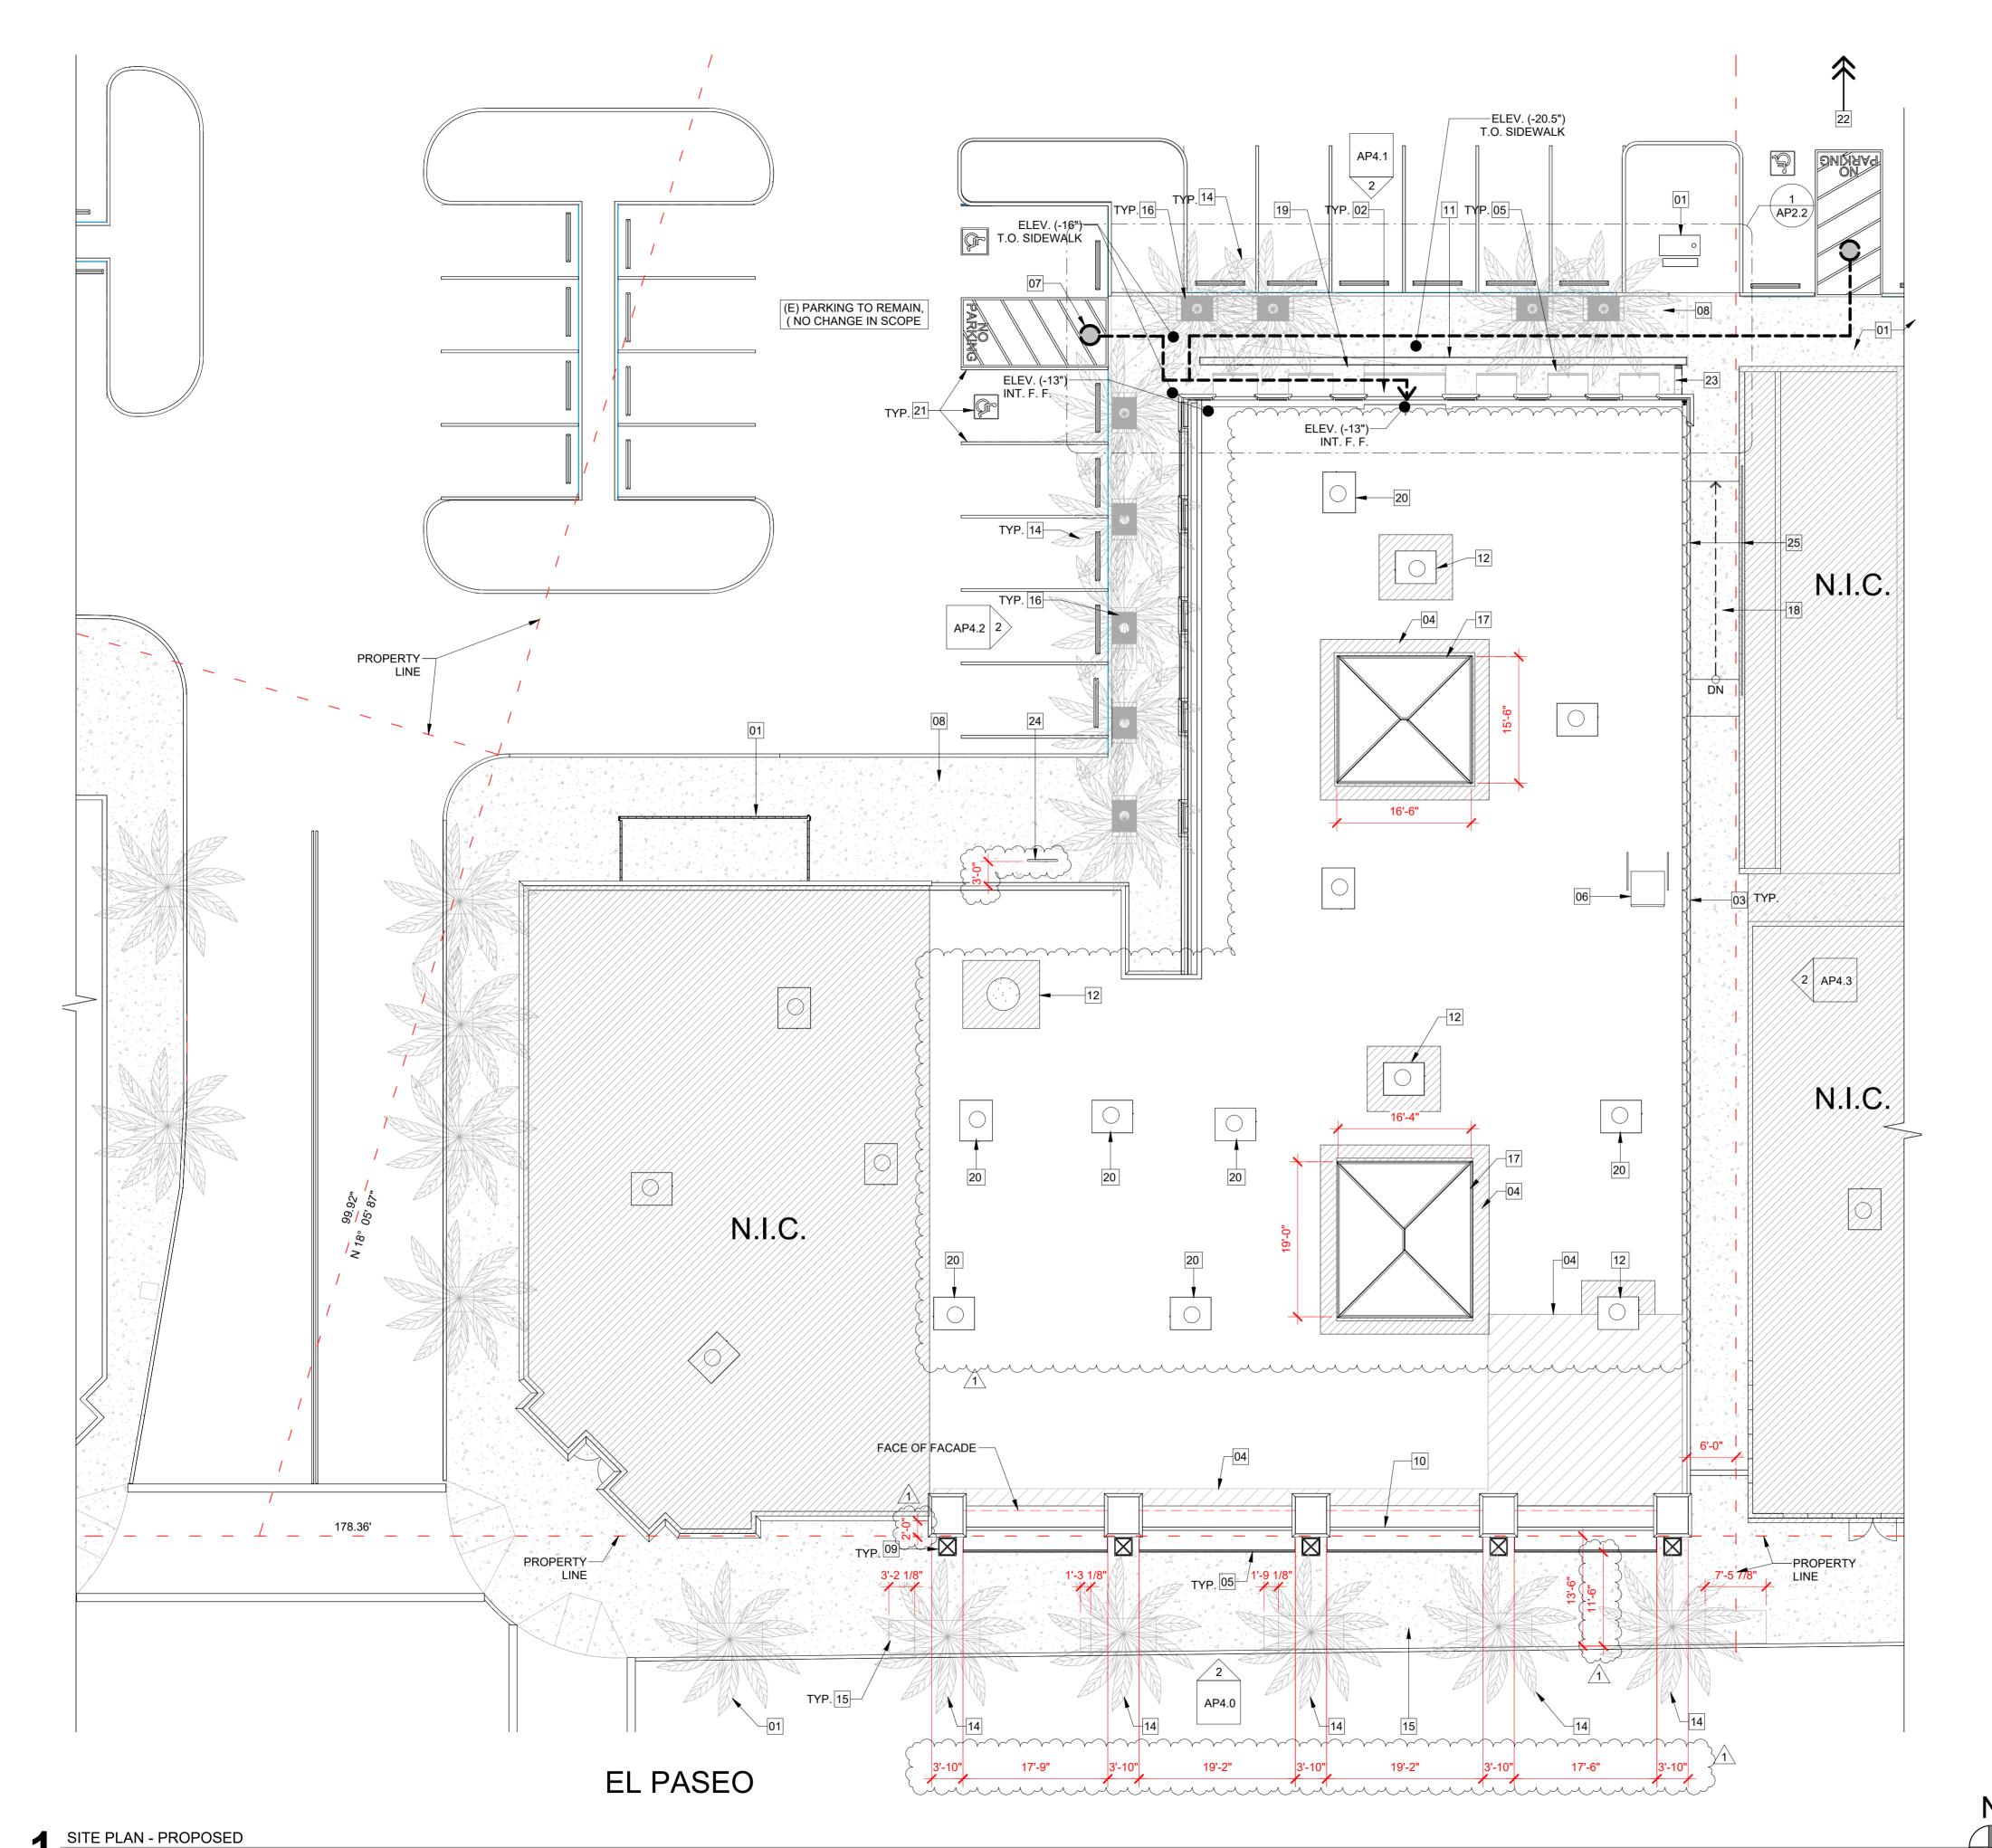

3/32" = 1'-0"

GENERAL NOTE:

- 1. ALL DIMS ARE GIVEN TO FACE OF FINISH & VERTICAL DIMS ARE FROM TOP OF FINISH
- CONTRACTOR TO FIELD VERIFY ALL DIMENSIONS OF (E) AND (N) WORK AND SHALL BE RESPONSIBLE FOR THEIR ACCURACY. ANY DISCREPANCIES BETWEEN DIMENSIONS IN THE FIELD AND ON THE DRAWINGS SHALL BE REPORTED TO THE ARCHITECT FOR DIRECTION PRIOR TO CONSTRUCTION.
- 3. WRITTEN DIMENSIONS GOVERN. DO NOT SCALE DRAWINGS.
- 4. ALL PATHWAYS MUST BE 36" WIDE (MIN.) VERIFY.
- ALL CONCRETE FEATHER WORK DONE AT THRESHOLDS TO MEET CBC STANDARDS PRIOR TO START.
- CALCS AND DETAILS FOR MOUNTING HANDRAILS AND CONNECTION OF GUARDRAILS SHALL BE PROVIDED FOR REVIEW AND APPROVAL PRIOR TO INSTALL FOR COMPLIANCE WITH CBC 3103F.11.

PLAN KEYNOTES:

- 01. EXISTING TO REMAIN.
- 02. (N) WALL, (SEE ELEV).
- 03. (N) CORNICE @ WALL PARAPET, TYP. (WHERE INDICATED, SEE ELEV).
- 04. (N) ROOF & FRAME TO MATCH (E) CONDITION.
- 05. (N) FABRIC AWNING WITH LIGHT FIXTURE, (SEE ELEV.)
- 06. (E) ROOF ACCESS HATCH TO REMAIN.
- 07. (E) ACCESSIBLE ROUTE FROM PARKING TO ENTRY.
- 08. (N) SIDEWALK, (SEE LANDSCAPE DWGS.).
- 09. (N) LIGHT FIXTURE WALL MOUNTED (S.L.D. & ELEV.).
- (E) ROOF PARAPET TO BE MODIFIED TO ACCOMMODATE (N) PILASTERS. AT FRONT & REAR OF BUILDING, (SEE ROOF PLAN, SHT. AP3.1).
- 11. (N) METAL PLANTERS, (SEE LANDSCAPE DWGS.).
- 12. (E) HVAC RTU RELOCATED.
- 13. (N) EXTERIOR LIGHTING, (SEE ELEV. & LIGHTING DWGS.).
- 14. (N) PALM TREES , (SEE LANDSCAPE DWGS). TYP.
- (N) SIDEWALK & PAVERS (WHERE INDICATED), (WHERE INDICATED). RELOCATE PALM TREES PER PLAN, TYP. (S.L.D.)
- (N) METAL GRATE (3'-0"x5'-0", TYP.) AT PALM TREES SIDEWALK, FLUSH WITH ADJACENT CONC. SIDEWALK, SLIP RESISTANT, (SEE PLAN FOR LOCATIONS).
- 17. (N) SKYLIGHT, (SEE ROOF PLANS, SHT. AP3.0 & AP3.1).
- 18. (N) CONC RAMP, (SEE LANDSCAPE DWGS).
- 19. (N) SLOPED WALKWAY MAX SLOPE OF 1:20, PER CBC 11B-403.3.
- 20. (E) ROOF AND MECHANICAL UNITS TO REMAIN.
- 21. (E) ACCESIBLE STALL & ACCESS AISLE TO REMAIN.
- 22. (LOCATION OF TRAH ENCLOSURE IN PARKING MEDIAN BEYOND. SEE VICINITY MAP, SHEET A0.0 FOR LOCATION.
- 23. (N) STAIR, (SEE LANDSCAPE DWGS).
- 24. (E) BIKE RACK RELOCATED.
- 25. (N) RAMP HANDRAIL (SEE LANDSCAPE DWGS.)

BIKE PARKING CACULATION:

REFERENCE PALM DESERT MUNICIPAL CODE SECTION 25.46.060:

TOTAL EXISTING PARKING STALLES 37

MIN BIKE PARKING SPACES REQ: 5% OF TTOAL REQUIRED PARKING STALLS 37 STALLS X .05 = 1.85 OR MINIMUM OF 2 BIKE PARKING STALLED REQUIRED WITH 200 FEET OF BUILDING ENTRANCE.

N

Client:



Project Title:

RH PALM DESERT GALLERY

73100 El Paseo, Suites 3-10 Palm Desert CA, 92260 APN 627-192-014

Architect:



FOUST ARCHITECTURE
4804 Mission St.
San Francisco, CA 94114
brian@foustarchitecture.com
T: 857.574.0010

Stamps:



Agency Approvals:

	PLANNING SUBMITTAL	12/20/2024
1	PLANNING RE-SUBMITTAL	01/31/2025
Autho	:	C C
Data		C.G

08/28/2024

As Indicated

2405

Issue Description

SITE PLAN - PROPOSED

Project No.

Sheet Title:

Scale:

AP1.1



LEGEND:

DEMOLITION / REMOVE



EXISTING TO REMAIN

UNDER SEPARATE PERMIT

GENERAL PLAN NOTES:

- 1 DEMOLITION DRAWINGS MAY NOT SHOW ENTIRE SCOPE. CONTRACTOR IS TO REMOVE ALL EXISTING CONSTRUCTION AND SYSTEMS TO FACILITATE CONSTRUCTION OF NEW SCOPE OF WORK.
- CONTRACTOR SHALL VERIFY FIELD CONDITIONS AND NOTIFY THE ARCHITECT OF ALL DISCREPANCIES BEFORE PROCEEDING WITH THE WORK.
- CONTRACTOR SHALL DEMOLISH IN AN ORDERLY AND CAREFUL MANNER AS REQUIRED TO ACCOMMODATE NEW WORK.
- CONTRACTOR SHALL PHASE DEMOLITION IN ACCORDANCE WITH AN OWNER APPROVED CONSTRUCTION SCHEDULE.
- 5. CONTRACTOR SHALL REPAIR ALL DEMOLITION IN EXCESS OF THAT REQUIRED AT NO COST TO THE OWNER.
- 6. CONTRACTOR SHALL BE RESPONSIBLE FOR PROTECTING AND MAINTAINING ALL EXISTING WORK TO REMAIN. DAMAGE TO EXISTING WORK SHALL BE REPAIRED BY THE CONTRACTOR AT NO COST TO THE OWNER.
- 7. CONTRACTOR SHALL PREVENT MOVEMENT OR SETTLEMENT OF STRUCTURE, PROVIDE AND PLACE BRACING AND SHORING, BE RESPONSIBLE FOR SAFETY AND SUPPORT OF STRUCTURE AND ASSUME LIABILITY FOR SUCH MOVEMENT, SETTLEMENT, DAMAGE OR INJURY.
- 8. CONTRACTOR SHALL CEASE OPERATIONS AND NOTIFY THE OWNER IMMEDIATELY IF THE SAFETY OF THE STRUCTURE APPEARS TO BE ENDANGERED. OPERATIONS HALL NOT BE RESUMED UNTIL SAFETY IS RESTORED.
- 9. CONTRACTOR SHALL PERFORM DEMOLITION IN ACCORDANCE WITH APPLICABLE AUTHORITIES HAVING JURISDICTION.
- 10. CONTRACTOR SHALL PROTECT EXISTING FOUNDATIONS, GRADE BEAMS AND SUPPORTING STRUCTURAL MEMBERS TO REMAIN. COORDINATE WITH STRUCTURAL DWGS. WHEN APPLICABLE.
- 11. CONTRACTOR SHALL TAKE ALL NECESSARY PRECAUTIONS TO PREVENT DAMAGE TO ADJACENT PROPERTIES DURING DEMOLITION & CONSTRUCTION. IN THE EVENT OF DAMAGE TO NEIGHBORING PROPERTIES, CONTRACTOR SHALL IMMEDIATELY CEASE. ALL OPERATIONS AND NOTIFY THE ARCHITECT & OWNER. OPERATIONS SHALL NOT BE RESUMED UNTIL SAID DAMAGE IS RESOLVED AND A SOLUTION APPROVED BY ARCHITECT AND OWNER.
- 12. CONTRACTOR SHALL REMOVE DEMOLISHED MATERIALS, TOOLS AND EQUIPMENT FROM SITE UPON COMPLETION OF WORK AND LEAVE THE SITE IN A CONDITION ACCEPTABLE TO THE ARCHITECT AND OWNER.
- 13. ALL DEMOLITION DEBRIS TO BE DISPOSED OF IN ACCORDANCE WITH ALL LOCAL APPLICABLE CODES AND CITY REQUIREMENTS.
- 14. CAP OFF ANY EXISITNG UTILITY NOT USED. DISCONNECT UTILITIES WITHIN DEMOLITION AREA IN COORDINATION WITH THE REQUIREMENTS OF THE NEW WORK. PROVIDE NOTIFICATION AND OBTAIN APPROVALS TO/FROM UTILITY COMPANIES AS REQUIRED.
- 15. INSPECTION FOR DEMOLITION AND REMOVAL OF HAZARDOUS MATERIALS IS UNDER SEPARATE CONTRACT BY OTHERS.
- 16. ALL ELECTRICAL TO BE RELOCATED ABOVE NEW CEILING. REWIRE TO MINIMIZE J-BOXES WITHIN NEW UNITS WITHIN WORK AREA.

DEMO KEYNOTES:

- 01. (E) WALL TO REMAIN
- 02. (E) WALL, DOOR AND WINDOW TO BE DEMOLISHED
- 03. (E) ELECTRICAL ROOM TO REMAIN
- 04. (E) TOILET ROOMS TO BE DEMOLISHED
- 05. DEMOLISH ALL INTERIOR FINISHES (WALL, FLOORING AND CEILING), LIGHTING, PLUMBING, ELECTRICAL, AND MECHANICAL, PREP FOR NEW FINISHES.
- 06. (E) TENANT DEMISING WALL TO REMAIN
- 07. (E) RAMP HANDRAIL TO BE DEMO PREPARE AREA TO RECEIVE (NEW) HANDRAIL.

NOTE: FOR KEYNOTES AND ADD'L INFO. SEE AP1.0

Client:



Project Title:

RH PALM DESERT GALLERY

73100 El Paseo, Suites 3-10 Palm Desert CA, 92260 APN 627-192-014

Architect:



FOUST ARCHITECTURE

4804 Mission St.
San Francisco, CA 94114
brian@foustarchitecture.com
T: 857.574.0010

Stamps:



Agency Approvals:

No Issue Description

PLANNING SUBMITTAL

12/20/2024

1 PLANNING RE-SUBMITTAL

01/31/2025

Author:

C.G.

08/28/2024

As Indicated

FLOOR PLAN - DEMO

Project No.

Sheet Title:

AP2.0

FLOOR PLAN - PROPOSED

1/8" = 1'-0"

LEGEND:

EXISTING TO REMAIN

NEW WALL, DOOR OR WINDOW

UNDER SEPARATE PERMIT

GENERAL NOTE:

- ALL DIMS ARE GIVEN TO FACE OF FINISH & VERTICAL DIMS ARE FROM TOP OF FINISH FLOOR, U.N.O.
- 2. CONTRACTOR TO FIELD VERIFY ALL DIMENSIONS OF (E) AND (N) WORK AND SHALL BE RESPONSIBLE FOR THEIR ACCURACY. ANY DISCREPANCIES BETWEEN DIMENSIONS IN THE FIELD AND ON THE DRAWINGS SHALL BE REPORTED TO THE ARCHITECT FOR DIRECTION PRIOR TO CONSTRUCTION.
- 3. WRITTEN DIMENSIONS GOVERN. DO NOT SCALE DRAWINGS.
- 4. ALL PATHWAYS MUST BE 36" WIDE (MIN.) VERIFY.
- ALL CONCRETE FEATHER WORK DONE AT THRESHOLDS TO MEET CBC STANDARDS PRIOR TO START.
- CALCS AND DETAILS FOR MOUNTING HANDRAILS AND CONNECTION OF GUARDRAILS SHALL BE PROVIDED FOR REVIEW AND APPROVAL PRIOR TO INSTALL FOR COMPLIANCE WITH CBC 3103F.11.

FLOOR PLAN KEYNOTES:

- 01. (E) WALL TO REMAIN.
- 02. (N) WALLS, DOOR OR WINDOW
- 03. (E) ELECTRICAL ROOM TO REMAIN
- 04. (N) TOILET ROOMS
- 05. PROVIDE ALL NEW INTERIOR FINISHES (WALL, FLOORING AND CEILING), LIGHTING, PLUMBING, ELECTRICAL, AND MECHANICAL.
- 06. (E) TENANT DEMISING WALL TO REMAIN
- 07. (N) EXTERIOR FACADE WALL
- 08. (N) AWINGS

NOTE: FOR KEYNOTES AND ADD'L INFO. SEE AP2.2

Client:



Project Title:

RH PALM DESERT GALLERY

73100 El Paseo, Suites 3-10 Palm Desert CA, 92260 APN 627-192-014

Architect:



FOUST ARCHITECTURE
4804 Mission St.
San Francisco, CA 94114
brian@foustarchitecture.com
T: 857.574.0010

Stamps:



Agency Approvals:

No	Issue Description	Date
	PLANNING SUBMITTAL	12/20/2024
1	PLANNING RE-SUBMITTAL	01/31/2025
Author	:	1
	•	C G

C.G. te: 08/28/2024

Project No.

Scale:


As Indicated

Sheet Title:

2405


FLOOR PLAN - PROPOSED

AP2.1

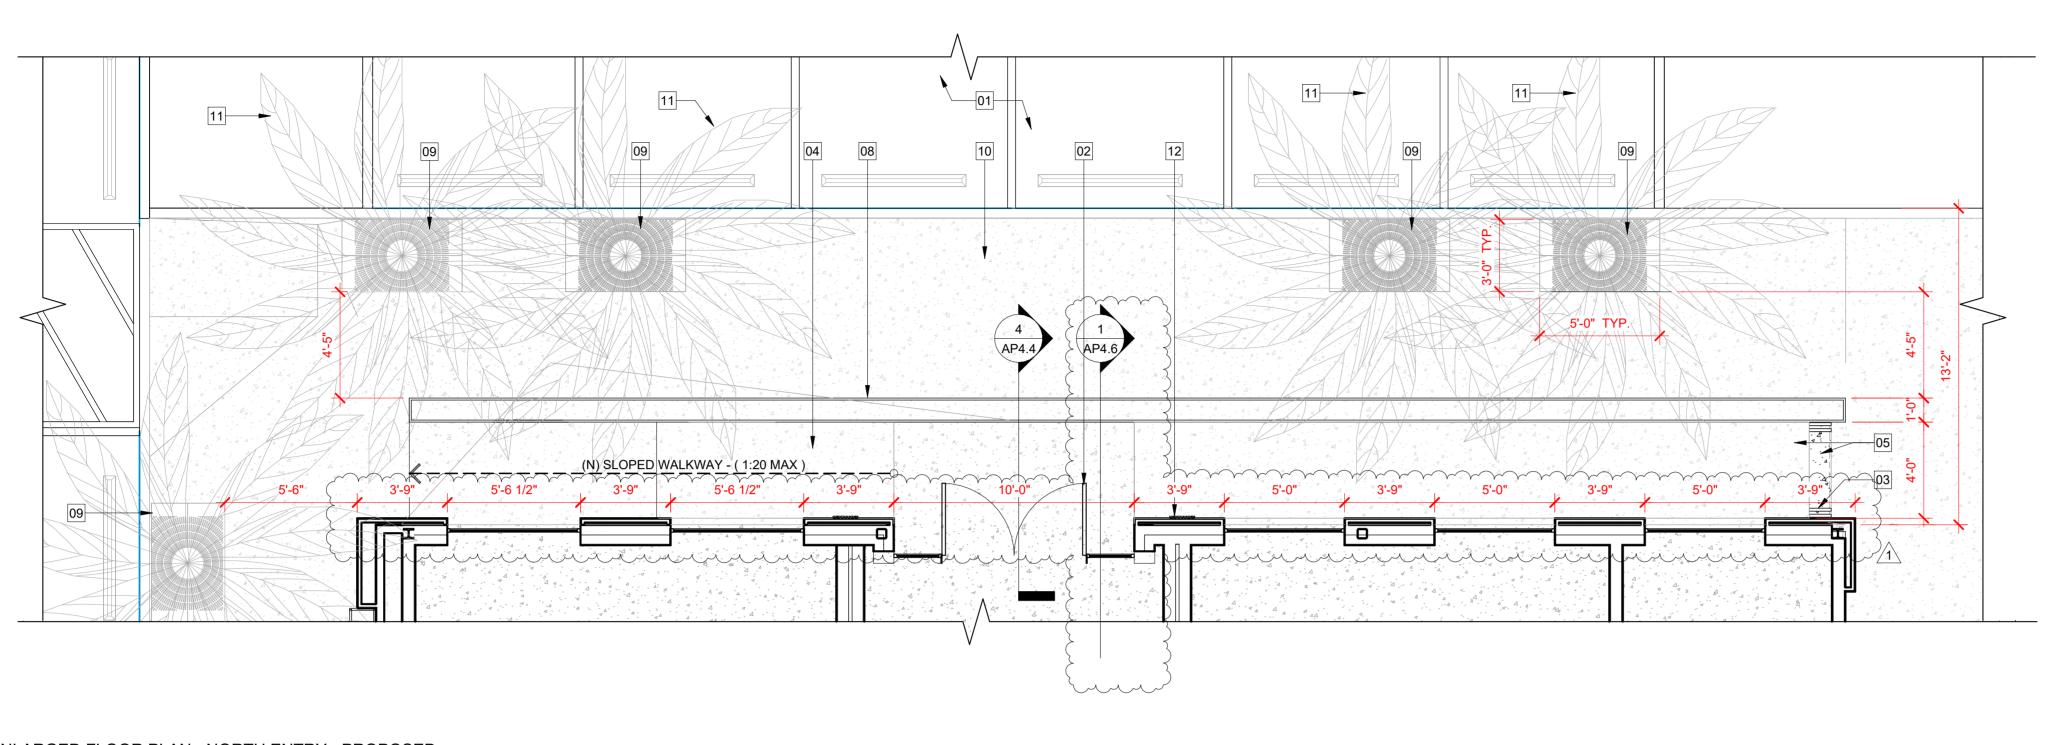

■ ENLARGED FLOOR PLAN - NORTH ENTRY - PROPOSED 1/4" = 1'-0"

> NOTE: FOR ADDITIONAL INFO. SEE SHEET AP4.4

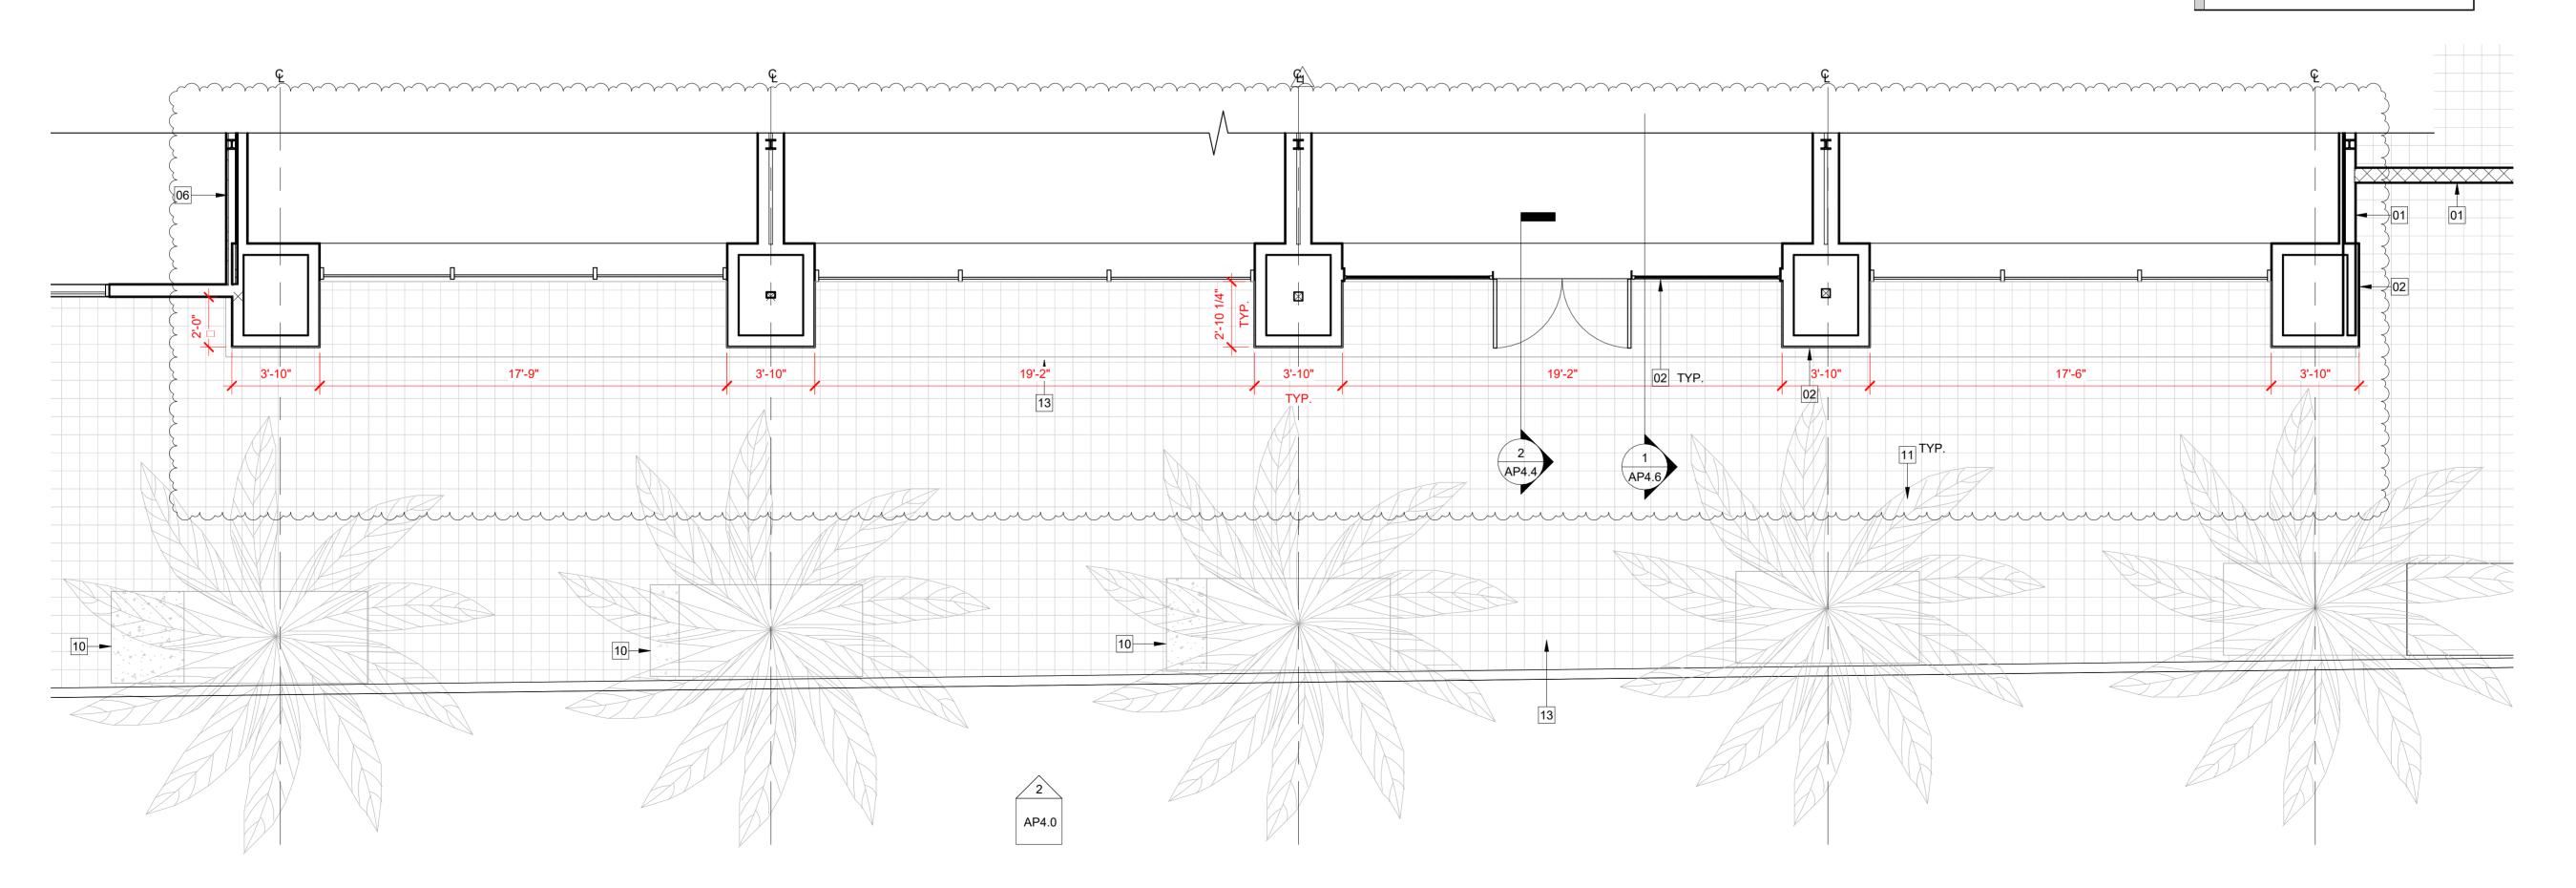

LEGEND:

EXISTING TO REMAIN

GENERAL NOTE:

- 1. ALL DIMS ARE GIVEN TO FACE OF FINISH & VERTICAL DIMS ARE FROM TOP OF FINISH
- CONTRACTOR TO FIELD VERIFY ALL DIMENSIONS OF (E) AND (N) WORK AND SHALL BE RESPONSIBLE FOR THEIR ACCURACY. ANY DISCREPANCIES BETWEEN DIMENSIONS IN THE FIELD AND ON THE DRAWINGS SHALL BE REPORTED TO THE ARCHITECT FOR DIRECTION PRIOR TO CONSTRUCTION.

NEW WALL, DOOR OR WINDOW

- 3. WRITTEN DIMENSIONS GOVERN. DO NOT SCALE DRAWINGS.
- 4. ALL PATHWAYS MUST BE 36" WIDE (MIN.) VERIFY.
- 5. ALL CONCRETE FEATHER WORK DONE AT THRESHOLDS TO MEET CBC STANDARDS PRIOR TO START.
- 6. CALCS AND DETAILS FOR MOUNTING HANDRAILS AND CONNECTION OF GUARDRAILS SHALL BE PROVIDED FOR REVIEW AND APPROVAL PRIOR TO INSTALL FOR COMPLIANCE WITH CBC 3103F.11.
- 7. SIGNAGE UNDER SEPARATE PERMIT.

FLOOR PLAN KEYNOTES:

- 01. EXISTING TO REMAIN
- 02. (N) WALLS, DOOR OR WINDOW
- 03. (N) STAIR HANDRAIL
- 04. (N) SLOPE WALKWAY (1:20 MAX). (SEE LANDSCAPE DWGS.)
- 05. (N) WALKWAY & STAIR, (SEE LANDSCAPE DWGS.)
- 06. (E) TENANT DEMISING WALL TO REMAIN
- 07. (N) EXTERIOR FACADE WALL
- 08. (N) PLANTER, SEE LANDSCAPE DRAWINGS
- 09. (N) TREE METAL GRATE (3'-0" x 5'-0", TYP.) LEVEL WITH CONCRETE WALKWAY, SLIP RESISTANT, TYP. (SEE LANDSCAPE DWGS.)
- 10. (N) SIDEWALK, (SEE LANDSCAPE DWGS)
- 11. (N) PALM TREE, (SEE LANDSCAPE DWGS)
- 12. (N) SIGNAGE, (UNDER SEPARATE PERMIT)
- 13. (N) SIDEWALK & PAVERS (WHERE INDICATED) (SEE LANDSCAPE DWGS).

Client:



Project Title:

RH PALM DESERT **GALLERY**

73100 El Paseo, Suites 3-10 Palm Desert CA, 92260 APN 627-192-014

Architect:



brian@foustarchitecture.com

T: 857.574.0010

Stamps:



Agency Approvals:

	PLANNING SUBMITTAL	12/20/2024	
1	PLANNING RE-SUBMITTAL	01/31/2025	
Auth	or:		
		C.G.	
Date:		_	
	08/28/202		

Issue Description

ENLARGED FLOOR PLAN -PROPOSED

Project No.

Sheet Title:

AP2.2

As Indicated



ROOF DEMO NOTES:

- 1 DEMOLITION DRAWINGS MAY NOT SHOW ENTIRE SCOPE. CONTRACTOR IS TO REMOVE ALL EXISTING CONSTRUCTION AND SYSTEMS TO FACILITATE CONSTRUCTION OF NEW SCOPE OF WORK.
- 2. CONTRACTOR SHALL VERIFY FIELD CONDITIONS AND NOTIFY THE ARCHITECT OF ALL DISCREPANCIES BEFORE PROCEEDING WITH THE WORK.
- 3. CONTRACTOR SHALL DEMOLISH IN AN ORDERLY AND CAREFUL MANNER AS REQUIRED TO ACCOMMODATE NEW WORK.
- 4. CONTRACTOR SHALL PHASE DEMOLITION IN ACCORDANCE WITH AN OWNER APPROVED CONSTRUCTION SCHEDULE.
- 5. CONTRACTOR SHALL REPAIR ALL DEMOLITION IN EXCESS OF THAT REQUIRED AT NO COST TO THE OWNER.
- 6. CONTRACTOR SHALL BE RESPONSIBLE FOR PROTECTING AND MAINTAINING ALL EXISTING WORK TO REMAIN. DAMAGE TO EXISTING WORK SHALL BE REPAIRED BY THE CONTRACTOR AT NO COST TO THE OWNER.
- 7. CONTRACTOR SHALL PREVENT MOVEMENT OR SETTLEMENT OF STRUCTURE, PROVIDE AND PLACE BRACING AND SHORING, BE RESPONSIBLE FOR SAFETY AND SUPPORT OF STRUCTURE AND ASSUME LIABILITY FOR SUCH MOVEMENT, SETTLEMENT, DAMAGE OR INJURY.
- 8. CONTRACTOR SHALL CEASE OPERATIONS AND NOTIFY THE OWNER IMMEDIATELY IF THE SAFETY OF THE STRUCTURE APPEARS TO BE ENDANGERED. OPERATIONS S HALL NOT BE RESUMED UNTIL SAFETY IS RESTORED.
- 9. CONTRACTOR SHALL PERFORM DEMOLITION IN ACCORDANCE WITH APPLICABLE AUTHORITIES HAVING JURISDICTION.
- 10. CONTRACTOR SHALL PROTECT EXISTING FOUNDATIONS, GRADE BEAMS AND SUPPORTING STRUCTURAL MEMBERS TO REMAIN. COORDINATE WITH STRUCTURAL DWGS. WHEN APPLICABLE.
- 11. CONTRACTOR SHALL TAKE ALL NECESSARY PRECAUTIONS TO PREVENT DAMAGE TO ADJACENT PROPERTIES DURING DEMOLITION & CONSTRUCTION. IN THE EVENT OF DAMAGE TO NEIGHBORING PROPERTIES, CONTRACTOR SHALL IMMEDIATELY CEASE. ALL OPERATIONS AND NOTIFY THE ARCHITECT & OWNER. OPERATIONS SHALL NOT BE RESUMED UNTIL SAID DAMAGE IS RESOLVED AND A SOLUTION APPROVED BY ARCHITECT AND OWNER.
- 12. CONTRACTOR SHALL REMOVE DEMOLISHED MATERIALS, TOOLS AND EQUIPMENT FROM SITE UPON COMPLETION OF WORK AND LEAVE THE SITE IN A CONDITION ACCEPTABLE TO THE ARCHITECT AND OWNER.
- 13. ALL DEMOLITION DEBRIS TO BE DISPOSED OF IN ACCORDANCE WITH ALL LOCAL APPLICABLE CODES AND CITY REQUIREMENTS.
- 14. CAP OFF ANY EXISITNG UTILITY NOT USED. DISCONNECT UTILITIES WITHIN DEMOLITION AREA IN COORDINATION WITH THE REQUIREMENTS OF THE NEW WORK. PROVIDE NOTIFICATION AND OBTAIN APPROVALS TO/FROM UTILITY COMPANIES AS REQUIRED.
- 15. INSPECTION FOR DEMOLITION AND REMOVAL OF HAZARDOUS MATERIALS IS UNDER SEPARATE CONTRACT BY OTHERS.
- 16. ALL ELECTRICAL TO BE RELOCATED ABOVE NEW CEILING. REWIRE TO MINIMIZE J-BOXES WITHIN NEW UNITS WITHIN WORK AREA.

ROOF DEMO KEYNOTES:

- 01. EXISTING TO REMAIN.
- 02. (E) ROOF MEMBRANE TO REMAIN.
- 03. (E) RTU TO REMAIN.
- 04. (E) ROOF DRAINS & SLOPED DRAINAGE TO REMAIN.
- 05. (E) ROOF AREA TO BE DEMO.
- 06. (E) RTU TO BE RELOCATED
- 07. (E) WALL TO REMAIN PREPARE TO RECEIVE PAINT, WHERE INDICATED. (SEE ELEV. & SCHED. AP4.0.)
- 08. EXISTING ROOF ACCESS HATCH TO REMAIN.
- 09. (E) WALL TO BE DEMO (SEE ELEV), TYP.
- 10. (E) CORNICE TO BE DEMO, WHERE INDICATED, TYP.

 11. (E) RTU TO BE DEMO, (S.M.D.)

Client:



Project Title:

RH PALM DESERT GALLERY

73100 El Paseo, Suites 3-10 Palm Desert CA, 92260 APN 627-192-014

Architect:



FOUST ARCHITECTURE
4804 Mission St.
San Francisco, CA 94114
brian@foustarchitecture.com
T: 857.574.0010

Stamps:



Agency Approvals:

No Issue Description
PLANNING SUBMITTAL
12/20/2024
1 PLANNING RE-SUBMITTAL
01/31/2025

Author:
C.G.

08/28/2024

As Indicated

2405


ROOF PLAN - DEMO

Project No.

Sheet Title:

Scale:

AP3.0

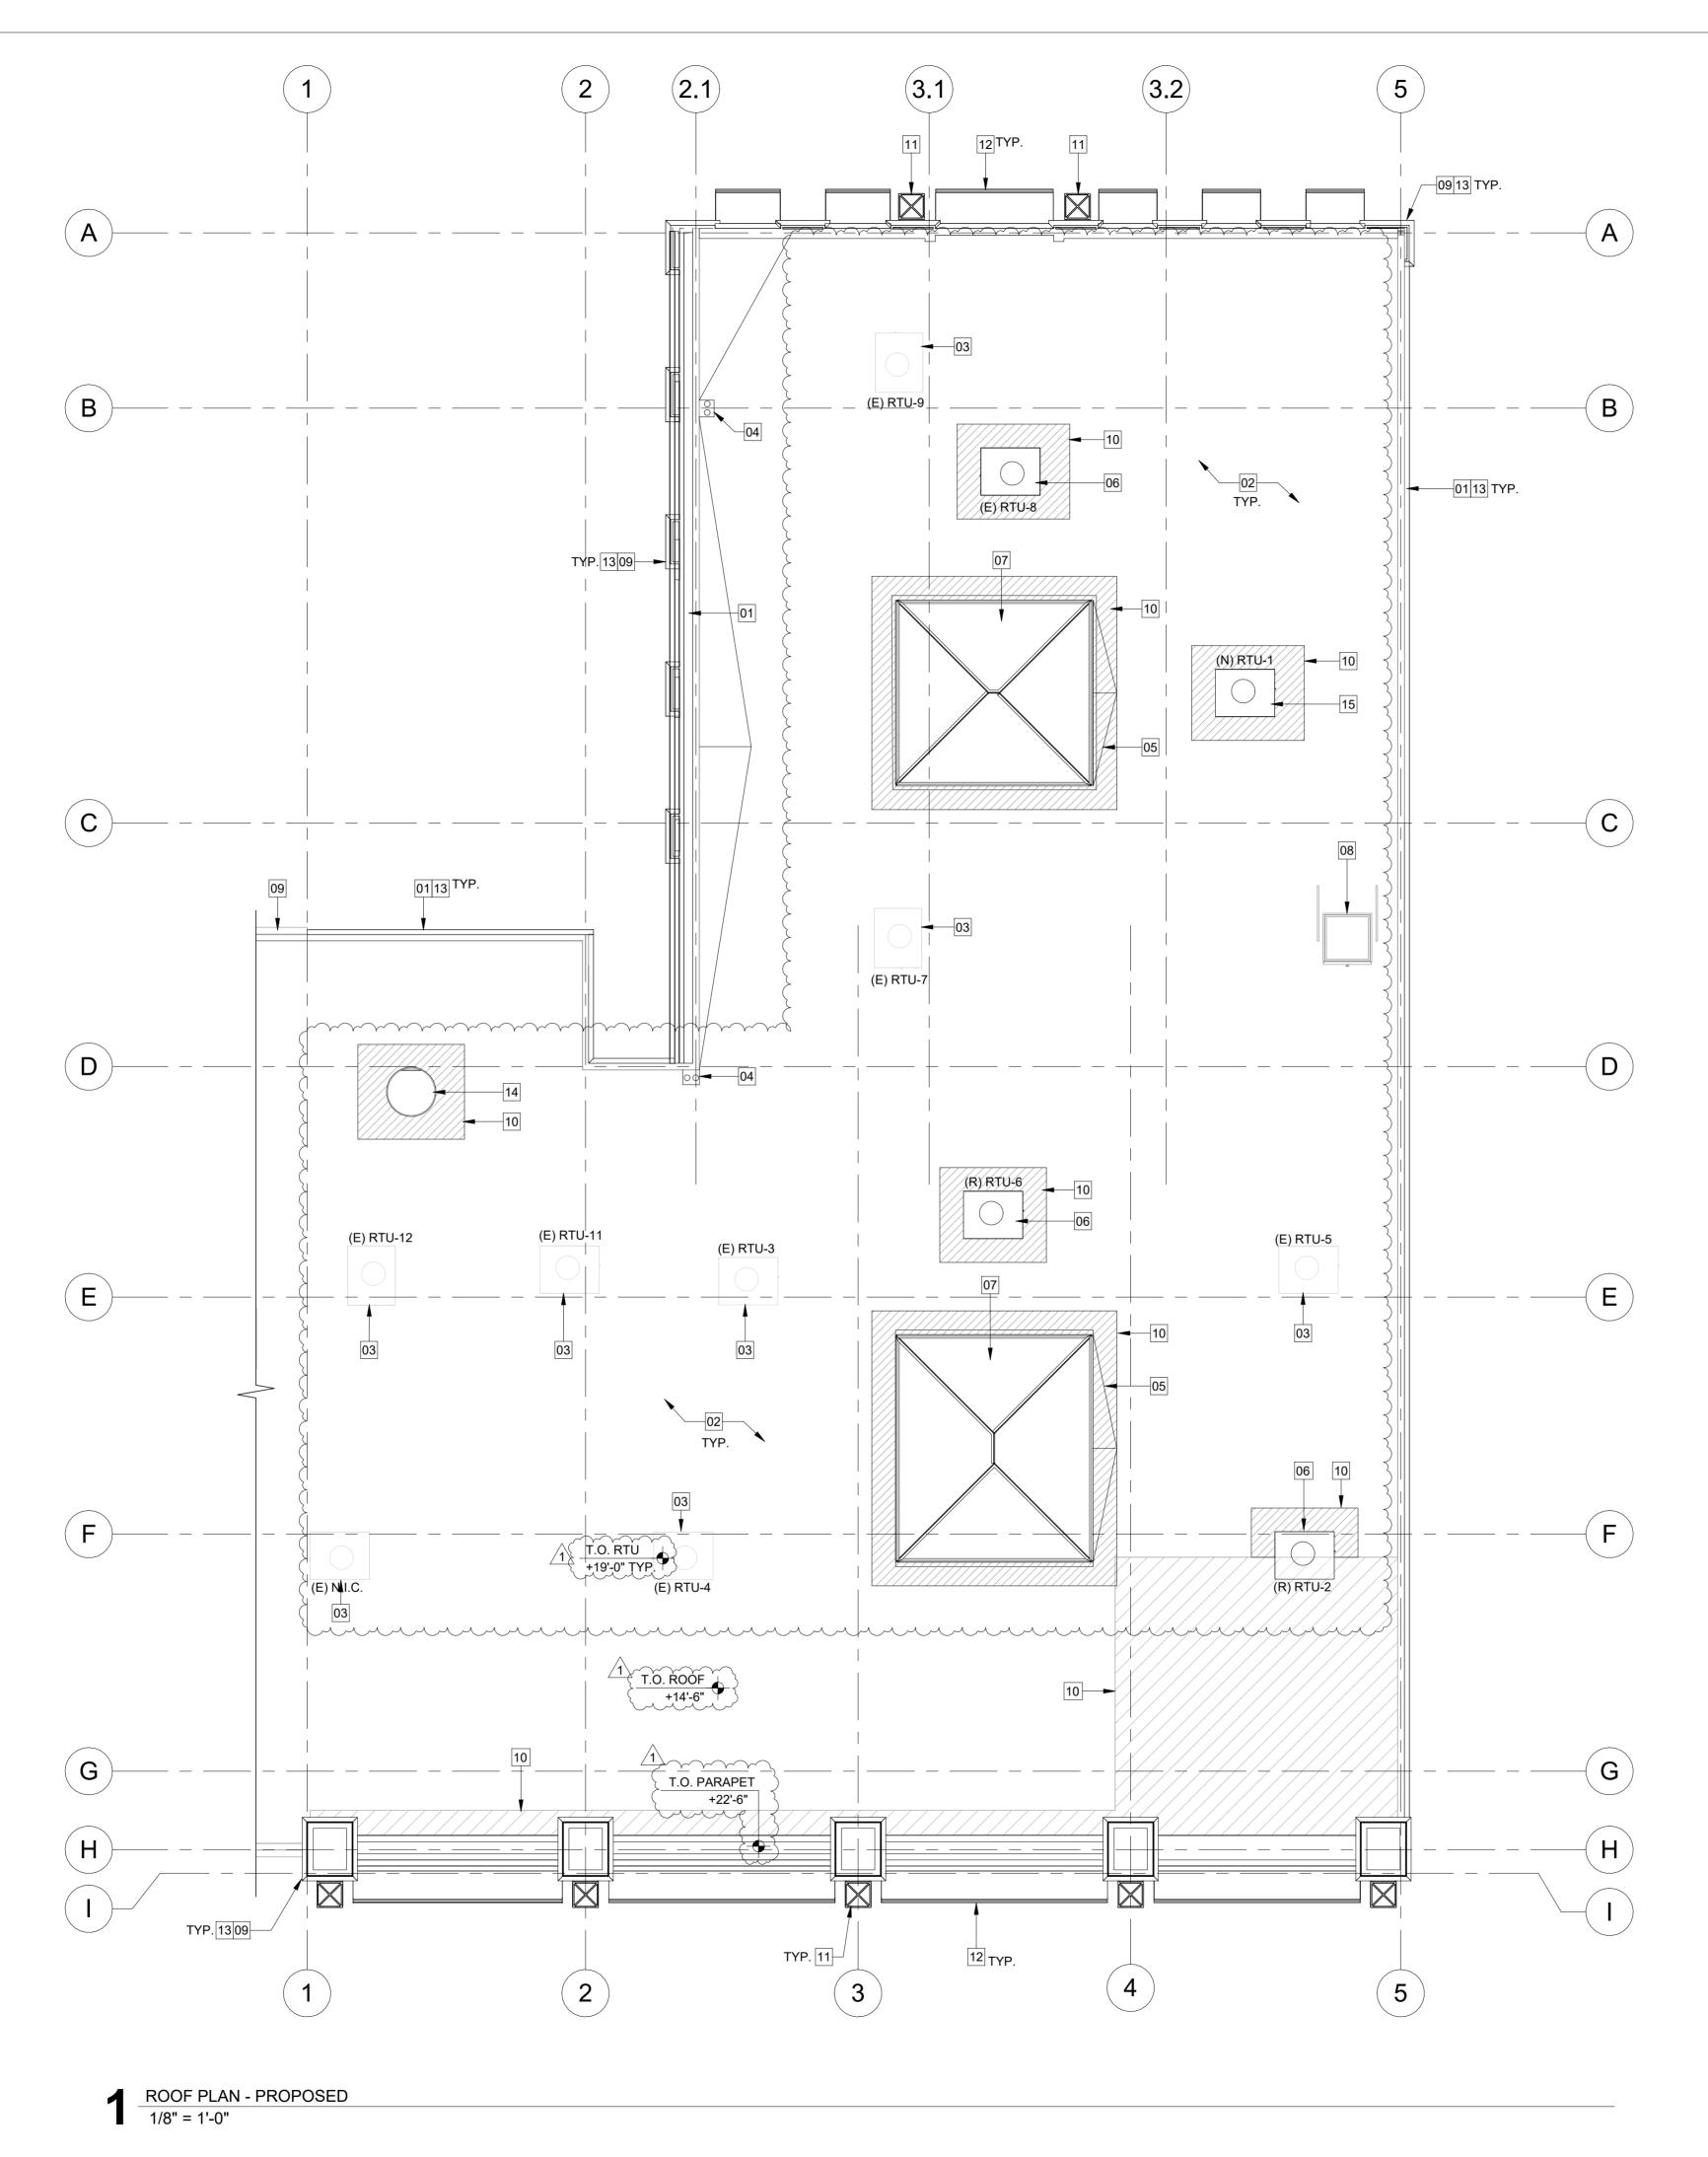

GENERAL ROOF NOTES:

- 1. ALL DIMS ARE GIVEN TO FACE OF FINISH & VERTICAL DIMS ARE FROM TOP OF FINISH FLOOR, U.N.O.
- CONTRACTOR TO FIELD VERIFY ALL DIMENSIONS OF (E) AND (N) WORK AND SHALL BE RESPONSIBLE FOR THEIR ACCURACY. ANY DISCREPANCIES BETWEEN DIMENSIONS IN THE FIELD AND ON THE DRAWINGS SHALL BE REPORTED TO THE ARCHITECT FOR DIRECTION PRIOR TO CONSTRUCTION.
- 3. WRITTEN DIMENSIONS GOVERN. DO NOT SCALE DRAWINGS.
- 4. ALL INT. WALL AND CLG. FINISHES TO COMPLY WITH BLDG. CODE REGS. AND REQUIREMENTS OF OTHER LOCAL CODES AND ORDINANCES FOR FLAME SPREAD.
- 5. INT PARTITION WALLS ARE NOT DESIGNED TO SUPPORT STRUCTURAL LOADS OF CASEWORK, EQUIPMENT OR ACCESSORIES. (U.O.N.)
- 6. ALL WOOD BLOCKING TO BE FIRE RETARDANT TREATED, TYPICAL. G.C. TO COORDINATE ALL WOOD BLOCKING AS REQUIRED FOR CASEWORK.
- 7. ALL PATHWAYS MUST BE 36" WIDE (MIN.) VERIFY.
- 8. ALL CONCRETE FEATHER WORK DONE AT THRESHOLDS TO MEET CBC STANDARDS PRIOR TO START.
- CALCS AND DETAILS FOR MOUNTING HANDRAILS AND CONNECTION OF GUARDRAILS SHALL BE PROVIDED FOR REVIEW AND APPROVAL PRIOR TO INSTALL FOR COMPLIANCE WITH CBC 3103F.11.
- 10. ALL ROOF PATCH AREAS TO MATCH (E) CONDITIONS, TYP.
- 11. ALL MECH. EQUIP. TYPE, LOCATIONS AND ADDITIONAL INFO., REFER TO MECH DWGS.

ROOF PLAN KEYNOTES:

- 01. (E) PARAPET WALLS TO REMAIN. REMOVE (E) CORNICE, PREPARE TO RECEIVE PAINT (WHERE INDICATED). SEE SCHEDULE AP4.0.
- 02. (E) ROOF MEMBRANE TO REMAIN.
- 03. (E) RTU TO REMAIN, (S.M.D.).
- 04. (E) ROOF DRAINS & SLOPED DRAINAGE TO REMAIN.
- 05. (N) ROOF CRICKET.
- 06. (E) RELOCATED RTU, (S.M.D.)
- 07. (N) SKYIGHT.
- 08. (E) ROOF ACCESS HATCH TO REMAIN.
- 09. (N) WALL, (SEE ELEVATIONS)
- 10. (N) ROOF PATCH AREA TO MATCH (E) CONDITIONS, TYP.
- 11. (N) LIGHT FIXTURE, WALL MOUNTED (SEE LIGHTING DWGS)
- 12. (N) FABRIC AWNING
- 13. (N) CORNICE, (SEE ELEVATIONS)
- 14. (N) MECH. EXHAUST FAN, (S.M.D.)
 - 15. (N) RTU, (S.M.D.)

Client:



Project Title:

RH PALM DESERT GALLERY

73100 El Paseo, Suites 3-10 Palm Desert CA, 92260 APN 627-192-014

Architect:



FOUST ARCHITECTURE
4804 Mission St.
San Francisco, CA 94114
brian@foustarchitecture.com
T: 857.574.0010

amps:



Agency Approvals:

No	Issue Description	Date
	PLANNING SUBMITTAL	12/20/2024
1	PLANNING RE-SUBMITTAL	01/31/2025
۸ . ا لم		
Author	•	0.0
		C.G

08/28/2024

As Indicated

ROOF PLAN - PROPOSED

Project No.

Sheet Title:

AP3.1

GENERAL NOTE: 1. ALL DIMS ARE GIVEN TO FACE OF FINISH & VERTICAL DIMS ARE FROM TOP OF FINISH FLOOR, U.N.O.

- 2. CONTRACTOR TO FIELD VERIFY ALL DIMENSIONS OF (E) AND (N) WORK AND SHALL BE RESPONSIBLE FOR THEIR ACCURACY. ANY DISCREPANCIES BETWEEN DIMENSIONS IN THE FIELD AND ON THE DRAWINGS SHALL BE REPORTED IMMEDIATELY TO THE ARCHITECT FOR DIRECTION PRIOR TO CONSTRUCTION.
- 3. WRITTEN DIMENSIONS GOVERN. DO NOT SCALE DRAWINGS.
- 4. ALL PATHWAYS MUST BE 36" WIDE (MIN.) VERIFY.
- 5. ALL CONCRETE FEATHER WORK DONE AT THRESHOLDS TO MEET CBC STANDARDS
- 6. CALCS AND DETAILS FOR MOUNTING HANDRAILS AND CONNECTION OF GUARDRAILS SHALL BE PROVIDED FOR REVIEW AND APPROVAL PRIOR TO INSTALL FOR COMPLIANCE WITH CBC 3103F.11.
- 7. ALL WALL INFILL TO MATCH (E) ADJACENT CONDITION, (SEE FINISH SCHED.) TYP.
- 8. FOR PALM TREES LOCATIONS & ADDITIONAL INFO. SEE LANDSCAPE DWGS.

ELEVATION KEYNOTES - DEMOLITION:

- 01. EXISTING TO REMAIN.
- 02. (E) DOOR & FRAME TO BE DEMO, TYP.
- 03. (E) WALL TO BE DEMO, TYP.
- 04. (E) AWNING TO BE DEMO, TYP.
- 05. (E) WINDOW & FRAME TO BE DEMO, TYP.
- 06. (E) PALM TREE TO BE DEMO, TYP. (SEE LANDSCAPE DWGS).
- 07. (E) CONC. SIDEWALK & PAVERS TO BE DEMO (PARTIAL / WHERE INDICATED), PREPARE AREA TO RECEIVE (N) CONC. & PAVERS (WHERE INDICATED). (SEE LANDSCAPE DWGS.).
- 08. (E) CONC. CURB TO BE DEMO, (SEE PLAN)
- 09. (E) BIKE RACK TO BE REMOVED, RETAIN TO RELOCATE, (SEE LANDSCAPE DWGS.).
- 10. (E) HANDRAIL TO BE DEMO (SEE PLAN & LANDSCAPE DWGS.).
- 11. (E) DOOR AND FRAME TO REMAIN, PREPARE TO REPAINT, TYP.
- 12. (E) CONC. RAMP TO BE DEMO PREPARE AREA TO RECEIVE (N) CONC.,

ELEVATION KEYNOTES (NEW CONST.)

- 21. (N) WALL (STUCCO PLASTER), TYP.
- 22. (N) WINDOW SYSTEM, (SEE PLAN).
- 23. (N) DOOR SYSTEM, (SEE PLAN).
- 24. (N) CORNICE (WHERE INDICATED), TYP.
- 25. (N) PIN LETTERING, (SEE SIGNAGE "UNDER SEPARATE PERMIT".).

26. (N) EXTERIOR LIGHT FIXTURE, (SEE LIGHTING DWGS.).

- 27. (N) FABRIC AWNING WITH LIGHT FIXTURE, (SEE ELEV & LIGHTING DWGS.). 28. (N) METAL BACK-LITE SIGNAGE, WALL MOUNTED (SEE ELEV. & SIGNAGE.
- "UNDER SEPARATE PERMIT"). 29. (N) BIKE RACK, (SEE LANDSCAPE DWGS)
- 30. (N) METAL GRATE AT PALM TREES SIDEWALK, FLUSH WITH ADJACENT CONC. SIDEWALK, SLIP RESISTANT, (SEE PLAN FOR LOCATIONS).
- 31. (N) HANDRAIL, (SEE LANDSCAPE DWGS.).
- 32. (N) STAIR (SEE LANDSCAPE DWGS.).

33. (N) MTL. PLANTER, (SEE LANDSCAPE DWGS.)

- 34. (N) SIDEWALK, (SEE LANDSCAPE DWGS.)
- 35. (N) RAMP, (SEE LANDSCAPE DWGS.)
- 36. (N) WALL INFILL, (SEE NOTES & FINISH SCHED.)
- 37. (N) PALM TREE, (SEE NOTES & LANDSCAPE DWGS)

___27 P-3 TYP.

26 P-2 TYP.

___21 P-1 TYP.

___22 P-2 TYP.

___23 P-2 TYP.

WINDOW WIDTH

B. O. Roof 14' - 0"

CIng. Line 10' - 0"

Project Title:

Client:

RH PALM DESERT GALLERY

73100 El Paseo, Suites 3-10 Palm Desert CA, 92260 APN 627-192-014

Architect:



brian@foustarchitecture.com

T: 857.574.0010

Stamps:



Agency Approvals:

	PLANNING SUBMITTAL	12/20/2024
1	PLANNING RE-SUBMITTAL	01/31/2025
Autho	γ.	'
, (311101	•	C.G
Date:		
		08/28/202
		<u> </u>

Issue Description


EXTERIOR ELEVATIONS

Project No.

Sheet Title:

AP4.0

As Indicated

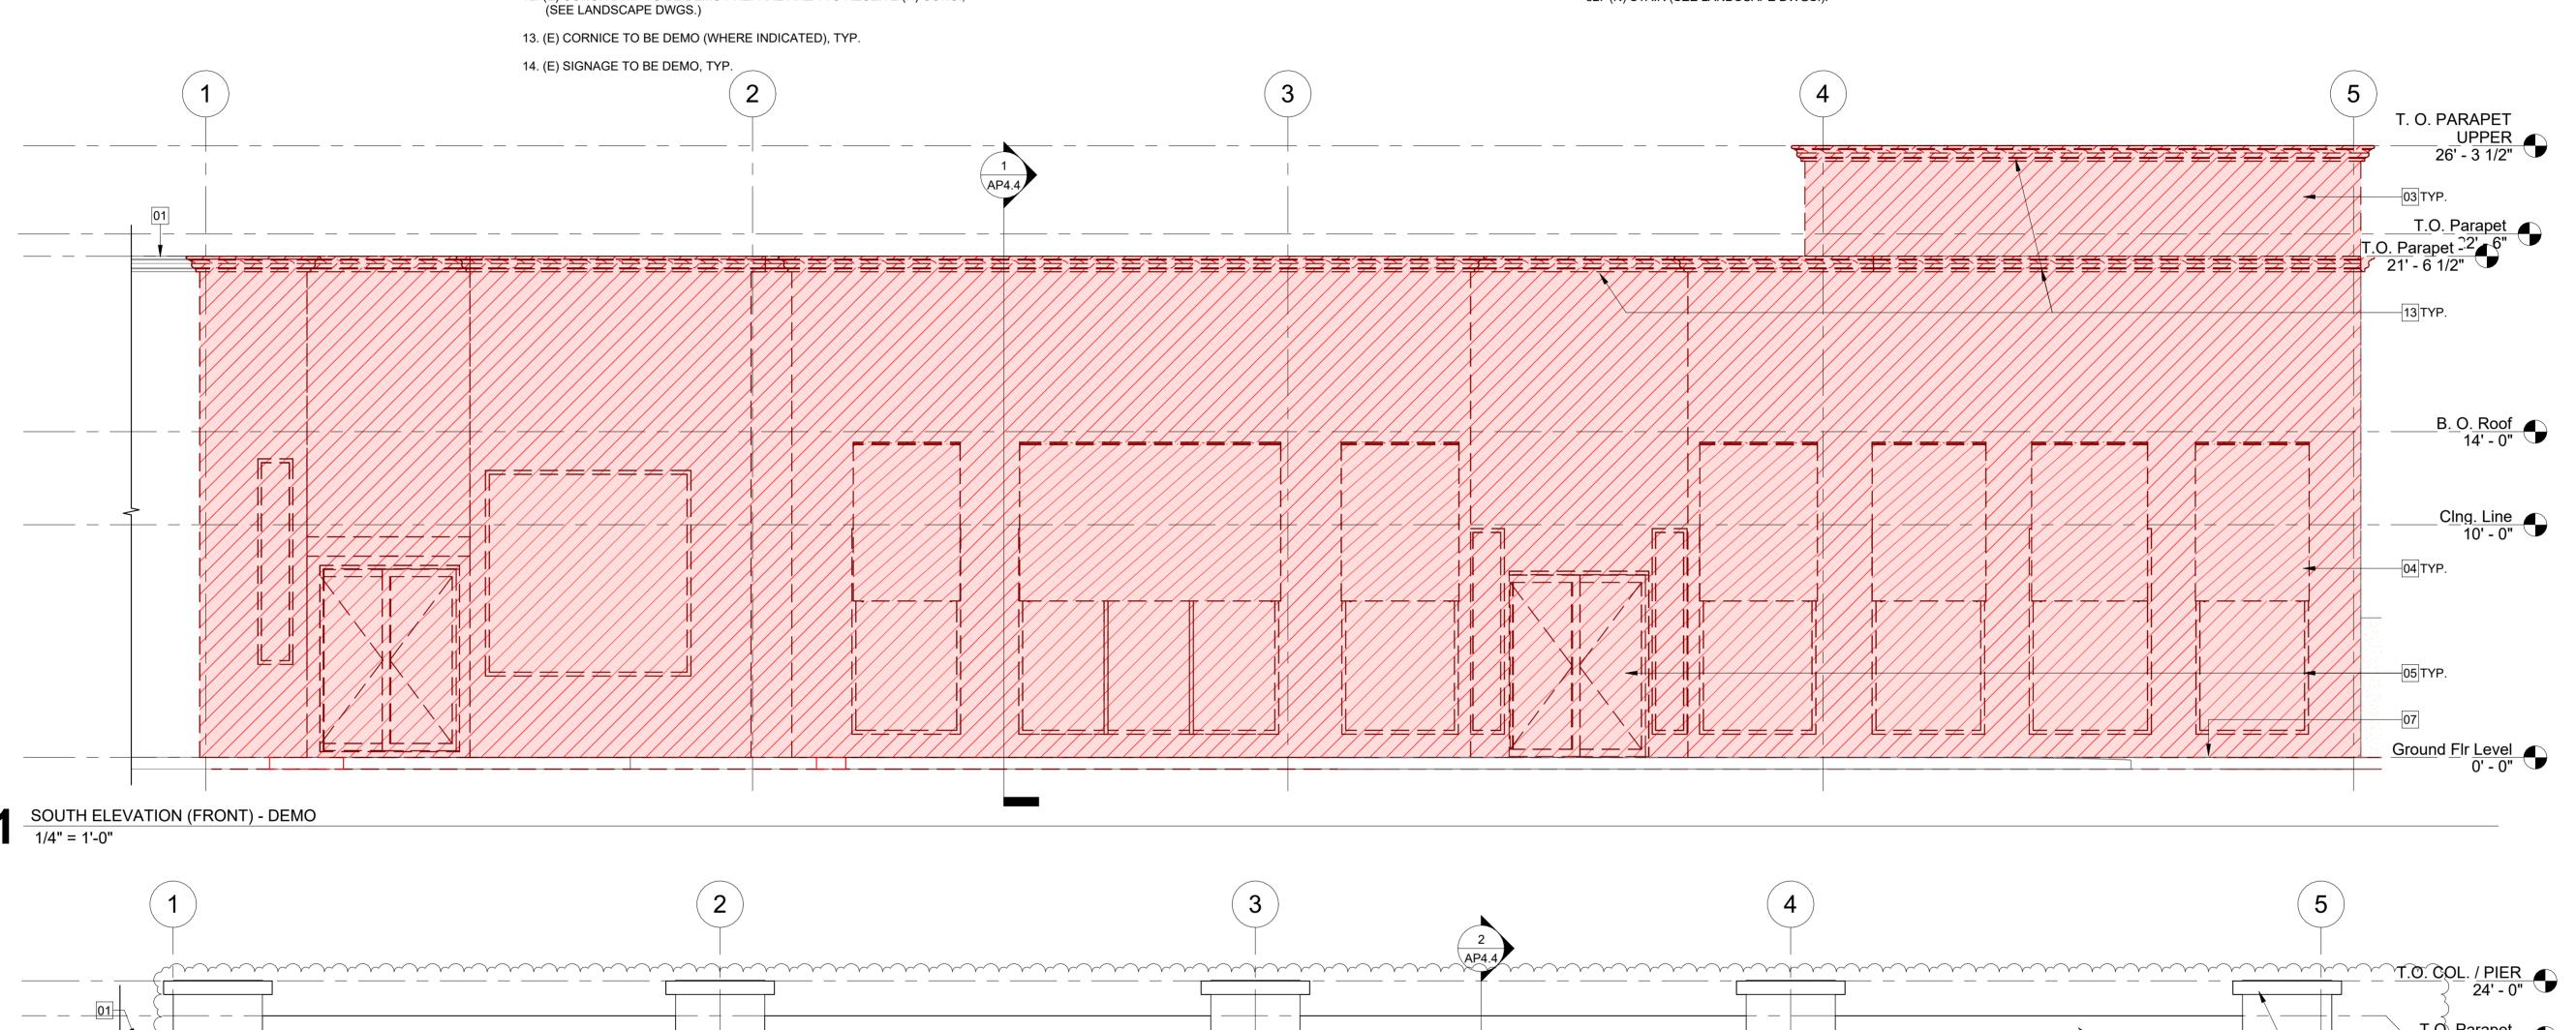

GENERAL NOTE: ALL DIMS ARE GIVEN TO FACE OF FINISH & VERTICAL DIMS ARE FROM TOP OF FINISH FLOOR, U.N.O. CONTRACTOR TO FIELD VERIFY ALL DIMENSIONS OF (E) AND (N) WORK AND SHALL BE RESPONSIBLE FOR THEIR ACCURACY. ANY DISCREPANCIES BETWEEN DIMENSIONS IN THE FIELD AND ON THE DRAWINGS SHALL BE REPORTED IMMEDIATELY TO THE ARCHITECT FOR DIRECTION PRIOR TO CONSTRUCTION. WRITTEN DIMENSIONS GOVERN. DO NOT SCALE DRAWINGS.

- 4. ALL PATHWAYS MUST BE 36" WIDE (MIN.) VERIFY.
- 5. ALL CONCRETE FEATHER WORK DONE AT THRESHOLDS TO MEET CBC STANDARDS PRIOR TO START.
- 6. CALCS AND DETAILS FOR MOUNTING HANDRAILS AND CONNECTION OF GUARDRAILS SHALL BE PROVIDED FOR REVIEW AND APPROVAL PRIOR TO INSTALL FOR COMPLIANCE WITH CBC 3103F.11.
- 7. ALL WALL INFILL TO MATCH (E) ADJACENT CONDITION, (SEE FINISH SCHED.) TYP.
- 8. FOR PALM TREES LOCATIONS & ADDITIONAL INFO. SEE LANDSCAPE DWGS.

ELEVATION KEYNOTES - DEMOLITION:

- 01. EXISTING TO REMAIN.
- 02. (E) DOOR & FRAME TO BE DEMO, TYP.
- 03. (E) WALL TO BE DEMO, TYP.
- 04. (E) AWNING TO BE DEMO, TYP.
- 05. (E) WINDOW & FRAME TO BE DEMO, TYP.
- 06. (E) PALM TREE TO BE DEMO, TYP. (SEE LANDSCAPE DWGS).
- 07. (E) CONC. SIDEWALK & PAVERS TO BE DEMO (PARTIAL / WHERE INDICATED), PREPARE AREA TO RECEIVE (N) CONC. & PAVERS (WHERE INDICATED). (SEE LANDSCAPE DWGS.).
- 08. (E) CONC. CURB TO BE DEMO, (SEE PLAN)
- 09. (E) BIKE RACK TO BE REMOVED, RETAIN TO RELOCATE, (SEE LANDSCAPE DWGS.).
- 10. (E) HANDRAIL TO BE DEMO (SEE PLAN & LANDSCAPE DWGS.).
- 11. (E) DOOR AND FRAME TO REMAIN, PREPARE TO REPAINT, TYP.
- 12. (E) CONC. RAMP TO BE DEMO PREPARE AREA TO RECEIVE (N) CONC., (SEE LANDSCAPE DWGS.)
- 13. (E) CORNICE TO BE DEMO (WHERE INDICATED), TYP.
- 14. (E) SIGNAGE TO BE DEMO, TYP.

ELEVATION KEYNOTES (NEW CONST.)

- 21. (N) WALL (STUCCO PLASTER), TYP.
- 22. (N) WINDOW SYSTEM, (SEE PLAN).
- 23. (N) DOOR SYSTEM, (SEE PLAN).
- 24. (N) CORNICE (WHERE INDICATED), TYP.
- 25. (N) PIN LETTERING, (SEE SIGNAGE "**UNDER SEPARATE PERMIT".**).
- 26. (N) EXTERIOR LIGHT FIXTURE, (SEE LIGHTING DWGS.).

 27. (N) FABRIC AWNING WITH LIGHT FIXTURE, (SEE ELEV & LIGHTING DWGS.).
- 28. (N) METAL BACK-LITE SIGNAGE, WALL MOUNTED (SEE ELEV. & SIGNAGE. "UNDER SEPARATE PERMIT").
- 29. (N) BIKE RACK, (SEE LANDSCAPE DWGS)
- 30. (N) METAL GRATE AT PALM TREES SIDEWALK, FLUSH WITH ADJACENT CONC. SIDEWALK, SLIP RESISTANT, (SEE PLAN FOR LOCATIONS).
- 31. (N) HANDRAIL, (SEE LANDSCAPE DWGS.).
- 32. (N) STAIR (SEE LANDSCAPE DWGS.).

33. (N) MTL. PLANTER, (SEE LANDSCAPE DWGS.)

- 34. (N) SIDEWALK, (SEE LANDSCAPE DWGS.)
- 35. (N) RAMP, (SEE LANDSCAPE DWGS.)
- 36. (N) WALL INFILL, (SEE NOTES & FINISH SCHED.)
- 37. (N) PALM TREE, (SEE NOTES & LANDSCAPE DWGS)

RH PALM DESERT
GALLERY

73100 El Paseo, Suites 3-10 Palm Desert CA, 92260 APN 627-192-014

Architect:

Client:

Project Title:



T: 857.574.0010

Stamps:



Agency Approvals:


No	Issue Description	Date
	PLANNING SUBMITTAL	12/20/2024
1	PLANNING RE-SUBMITTAL	01/31/2025
Author		
		C.G

Project No. 2405
Scale:

Sheet Title:

EXTERIOR ELEVATIONS

AP4.1

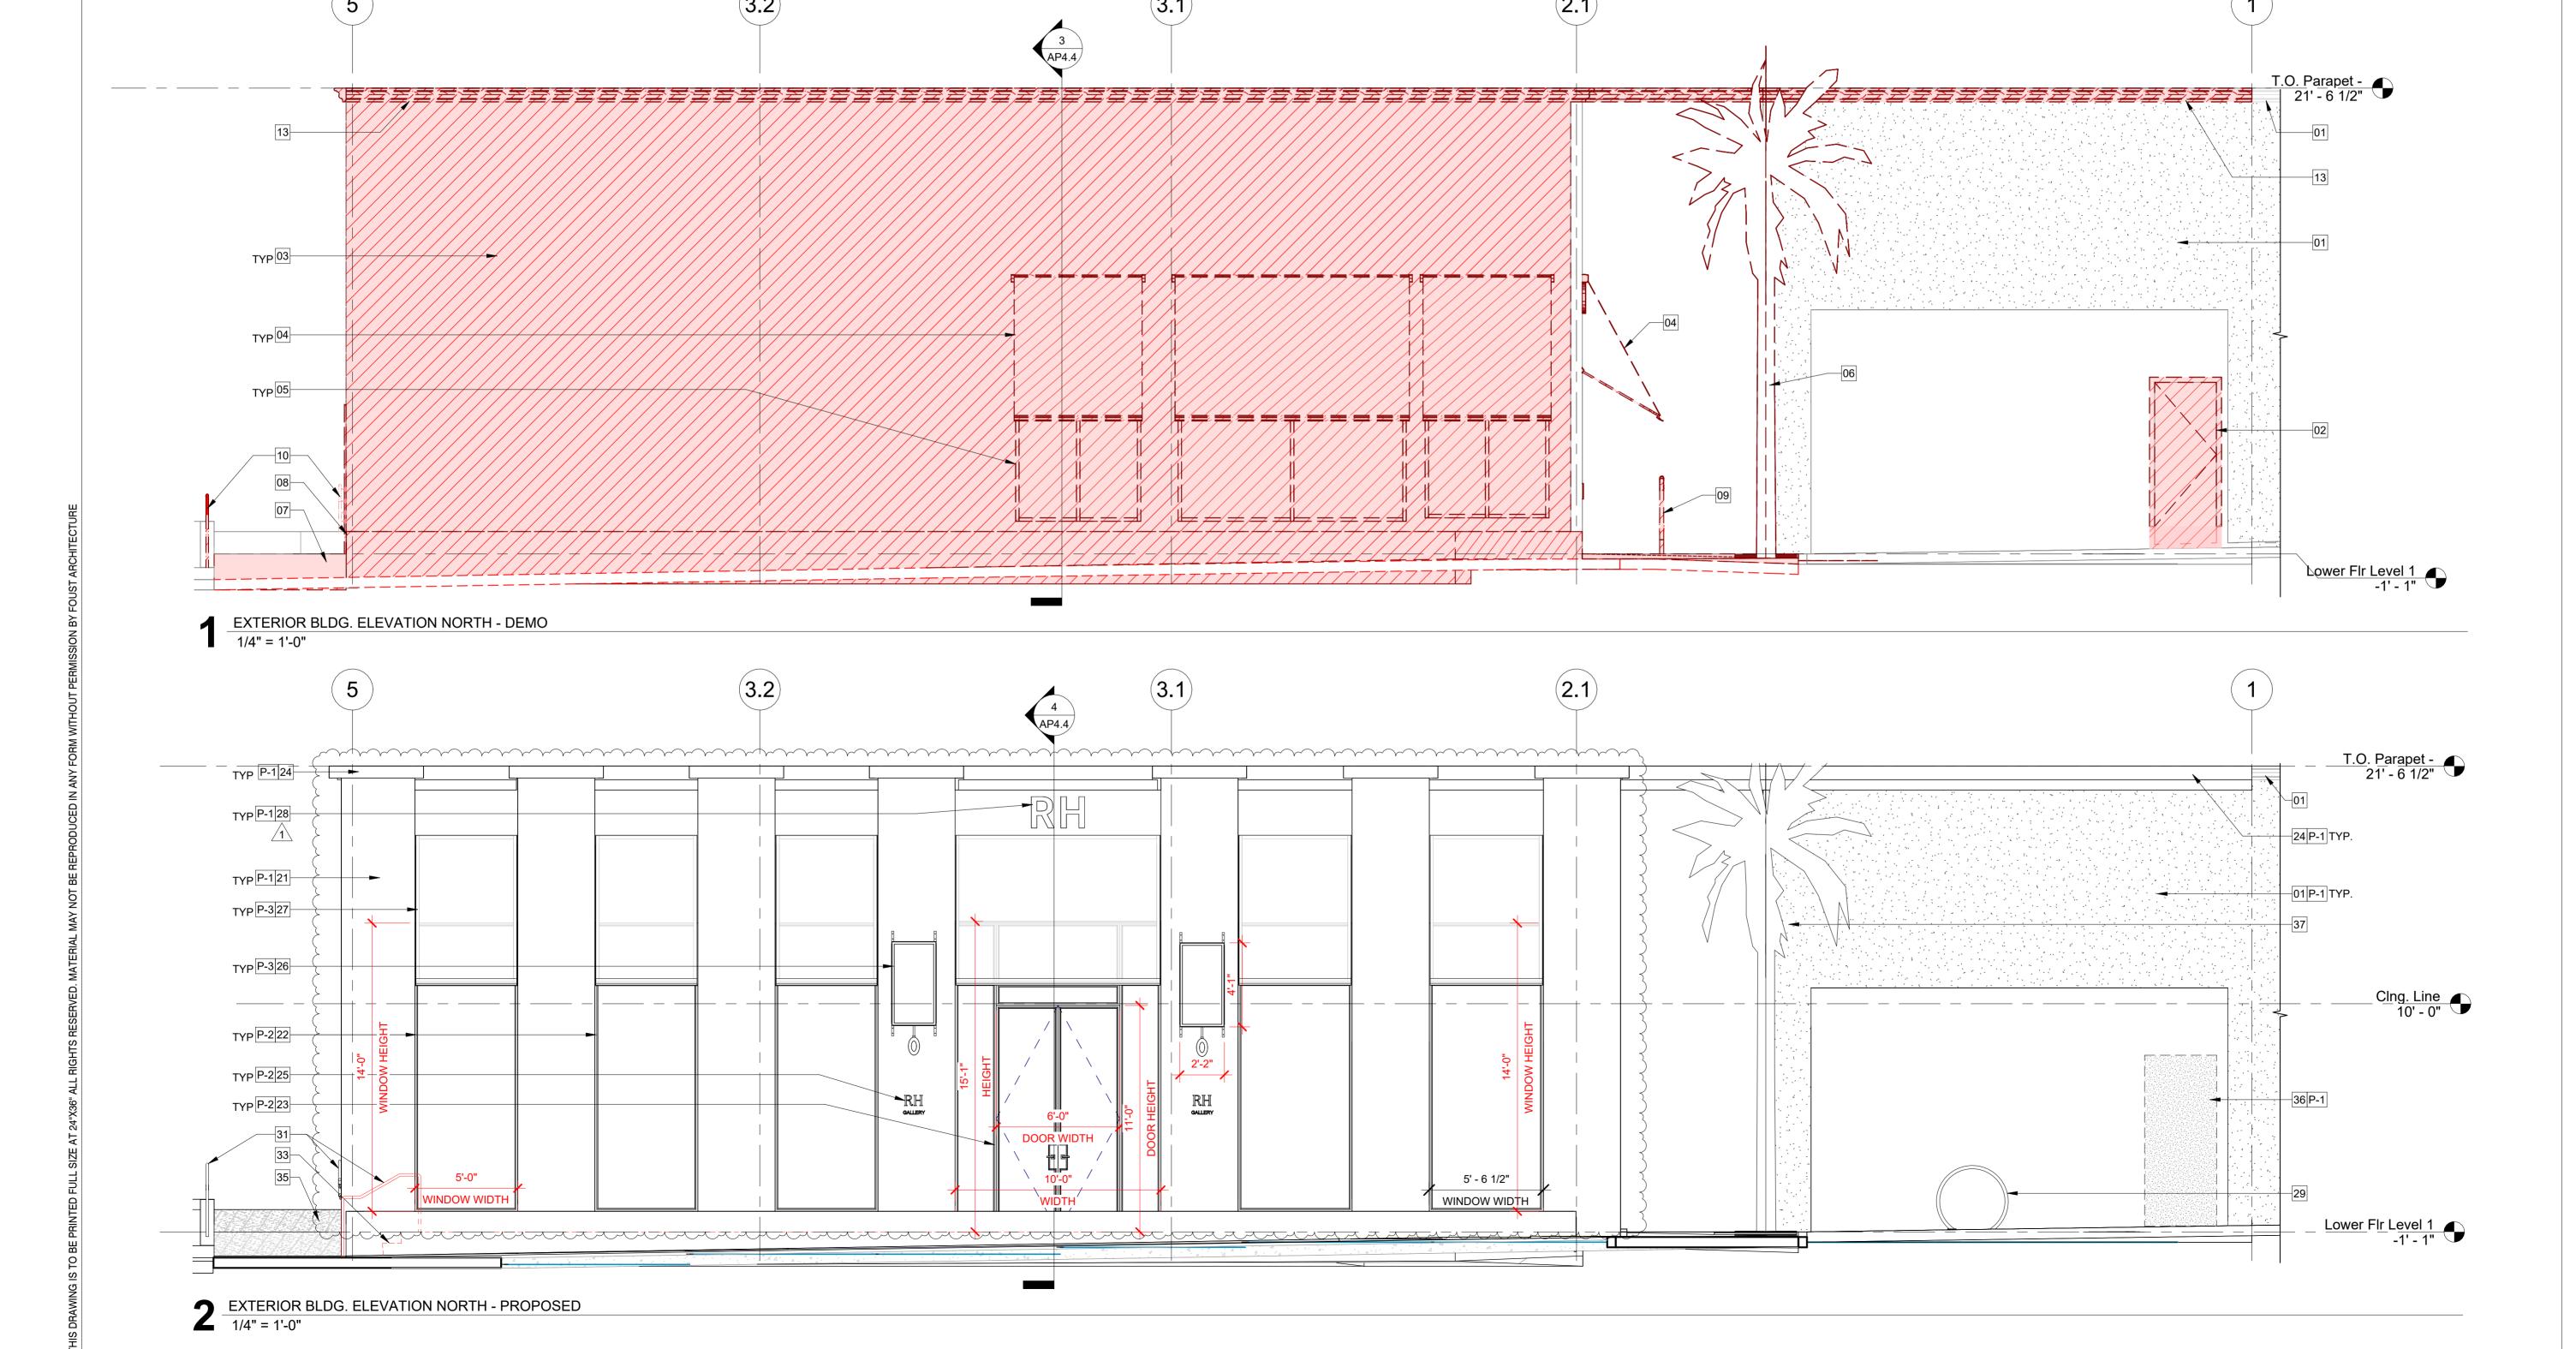

GENERAL NOTE:

- 1. ALL DIMS ARE GIVEN TO FACE OF FINISH & VERTICAL DIMS ARE FROM TOP OF FINISH FLOOR, U.N.O.
- 2. CONTRACTOR TO FIELD VERIFY ALL DIMENSIONS OF (E) AND (N) WORK AND SHALL BE RESPONSIBLE FOR THEIR ACCURACY. ANY DISCREPANCIES BETWEEN DIMENSIONS IN THE FIELD AND ON THE DRAWINGS SHALL BE REPORTED IMMEDIATELY TO THE ARCHITECT FOR DIRECTION PRIOR TO CONSTRUCTION.
- 3. WRITTEN DIMENSIONS GOVERN. DO NOT SCALE DRAWINGS.
- 4. ALL PATHWAYS MUST BE 36" WIDE (MIN.) VERIFY.
- 5. ALL CONCRETE FEATHER WORK DONE AT THRESHOLDS TO MEET CBC STANDARDS PRIOR TO START.
- 6. CALCS AND DETAILS FOR MOUNTING HANDRAILS AND CONNECTION OF GUARDRAILS SHALL BE PROVIDED FOR REVIEW AND APPROVAL PRIOR TO INSTALL FOR COMPLIANCE WITH CBC 3103F.11.
- 7. ALL WALL INFILL TO MATCH (E) ADJACENT CONDITION, (SEE FINISH SCHED.) TYP.
- 8. FOR PALM TREES LOCATIONS & ADDITIONAL INFO. SEE LANDSCAPE DWGS.

ELEVATION KEYNOTES - DEMOLITION:

01. EXISTING TO REMAIN.

2 EXTERIOR BLDG. ELEVATION WEST - PROPOSED 1/4" = 1'-0"

- 02. (E) DOOR & FRAME TO BE DEMO, TYP.
- 03. (E) WALL TO BE DEMO, TYP.
- 04. (E) AWNING TO BE DEMO, TYP.
- 05. (E) WINDOW & FRAME TO BE DEMO, TYP.
- 06. (E) PALM TREE TO BE DEMO, TYP. (SEE LANDSCAPE DWGS).
- 07. (E) CONC. SIDEWALK & PAVERS TO BE DEMO (PARTIAL / WHERE INDICATED), PREPARE AREA TO RECEIVE (N) CONC. & PAVERS (WHERE INDICATED). (SEE LANDSCAPE DWGS.).
- 08. (E) CONC. CURB TO BE DEMO, (SEE PLAN)
- 09. (E) BIKE RACK TO BE REMOVED, RETAIN TO RELOCATE, (SEE LANDSCAPE DWGS.).

ELEVATION KEYNOTES (NEW CONST.)

- 21. (N) WALL (STUCCO PLASTER), TYP.
- 22. (N) WINDOW SYSTEM, (SEE PLAN).
- 23. (N) DOOR SYSTEM, (SEE PLAN).
- 24. (N) CORNICE (WHERE INDICATED), TYP.
- 25. (N) PIN LETTERING, (SEE SIGNAGE "UNDER SEPARATE PERMIT".).
- 26. (N) EXTERIOR LIGHT FIXTURE, (SEE LIGHTING DWGS.).
- 27. (N) FABRIC AWNING WITH LIGHT FIXTURE, (SEE ELEV & LIGHTING DWGS.).
- 28. (N) METAL BACK-LITE SIGNAGE, WALL MOUNTED (SEE ELEV. & SIGNAGE. "UNDER SEPARATE PERMIT").
- 29. (N) BIKE RACK, (SEE LANDSCAPE DWGS)

33. (N) 9" DEEP PLANTER, (SEE LANDSCAPE DWGS.)
34. (N) SIDEWALK, (SEE LANDSCAPE DWGS.)

- 35. (N) RAMP, (SEE LANDSCAPE DWGS.)
- 36. (N) WALL INFILL, (SEE NOTES & FINISH SCHED.)
- 37. (N) PALM TREE, (SEE NOTES & LANDSCAPE DWGS)

Project Title:

Client:

RH PALM DESERT GALLERY

73100 El Paseo, Suites 3-10 Palm Desert CA, 92260 APN 627-192-014

Architect:



FOUST ARCHITECTURE
4804 Mission St.
San Francisco, CA 94114
brian@foustarchitecture.com
T: 857.574.0010

Stamps:



Agency Approvals:

No	Issue Description	Date
	PLANNING SUBMITTAL	12/20/2024
1	PLANNING RE-SUBMITTAL	01/31/2025
Author	•	
		C.G
- .		

08/28/2024


As Indicated

EXTERIOR ELEVATIONS

Project No.

Sheet Title:

AP4.2

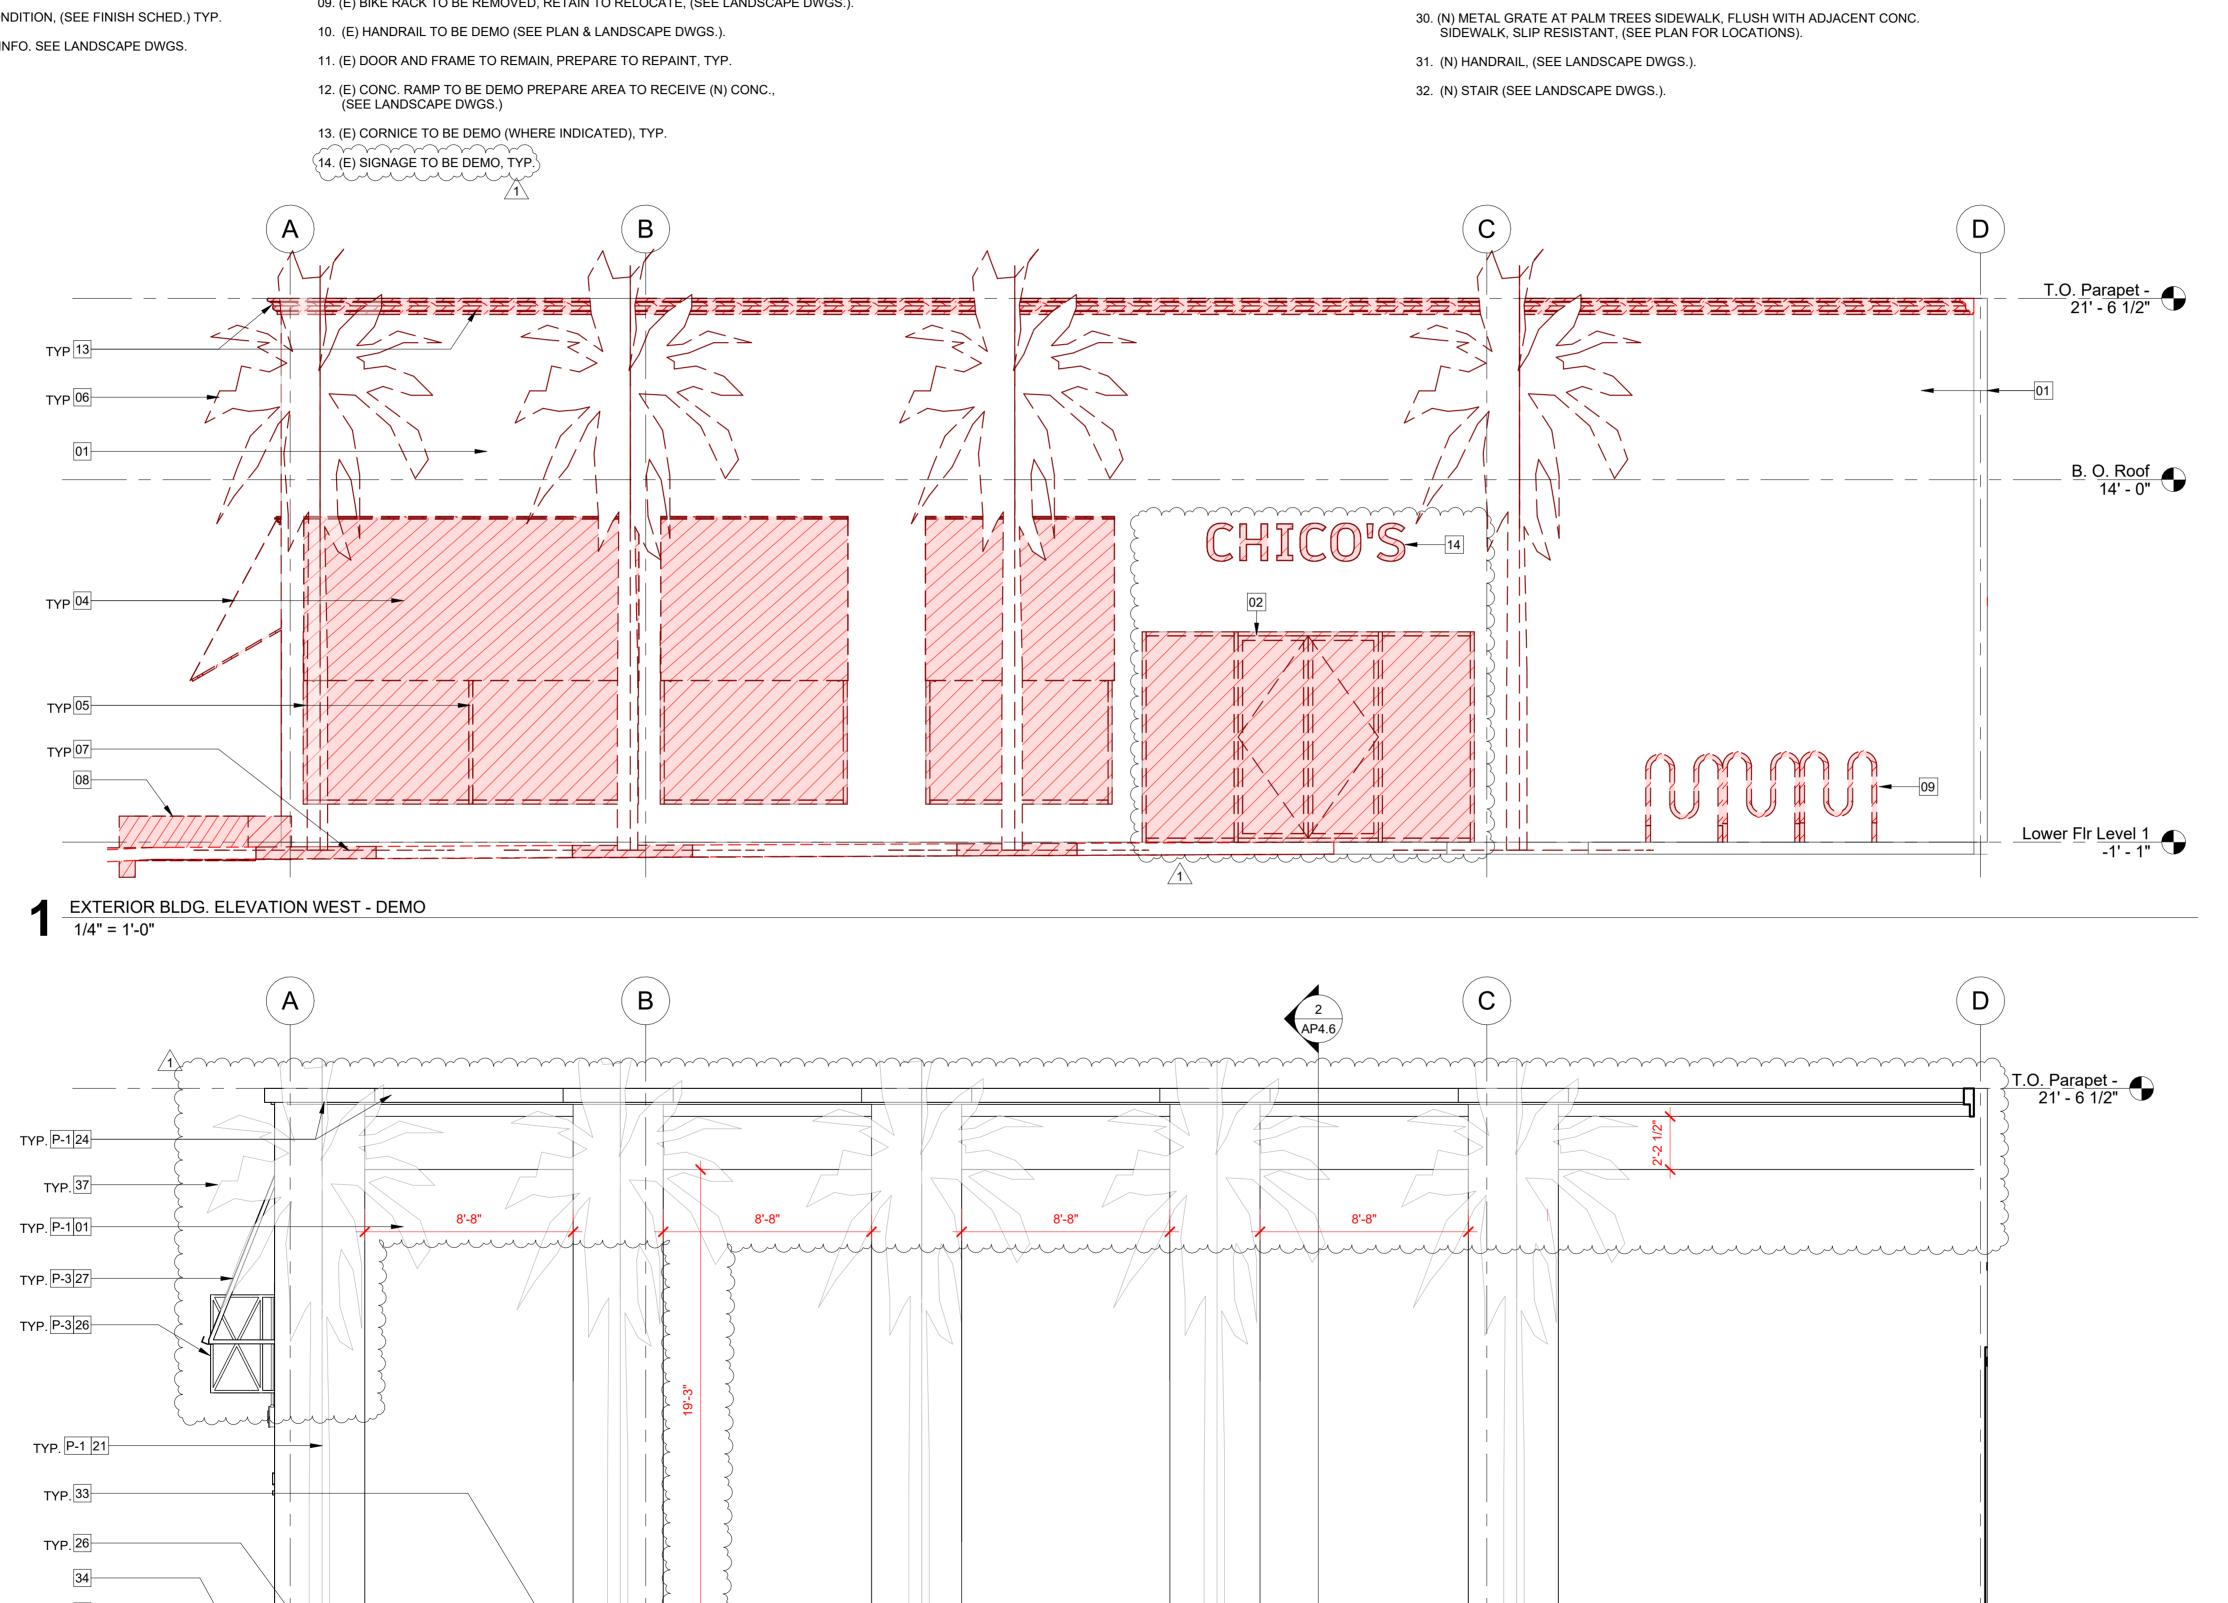

 \Box

GENERAL NOTE: ELEVATION KEYNOTES - DEMOLITION: ELEVATION KEYNOTES (NEW CONST.) 1. ALL DIMS ARE GIVEN TO FACE OF FINISH & VERTICAL DIMS ARE FROM TOP OF FINISH 01. EXISTING TO REMAIN. 21. (N) WALL (STUCCO PLASTER), TYP. 33. (N) MTL. PLANTER, (SEE LANDSCAPE DWGS.) FLOOR, U.N.O. 02. (E) DOOR & FRAME TO BE DEMO, TYP. 22. (N) WINDOW SYSTEM, (SEE PLAN). 34. (N) SIDEWALK, (SEE LANDSCAPE DWGS.) 2. CONTRACTOR TO FIELD VERIFY ALL DIMENSIONS OF (E) AND (N) WORK AND SHALL BE RESPONSIBLE FOR THEIR ACCURACY. ANY DISCREPANCIES BETWEEN 03. (E) WALL TO BE DEMO, TYP. 23. (N) DOOR SYSTEM, (SEE PLAN). 35. (N) RAMP, (SEE LANDSCAPE DWGS.) DIMENSIONS IN THE FIELD AND ON THE DRAWINGS SHALL BE REPORTED IMMEDIATELY TO THE ARCHITECT FOR DIRECTION PRIOR TO CONSTRUCTION. 04. (E) AWNING TO BE DEMO, TYP. 24. (N) CORNICE (WHERE INDICATED), TYP. 36. (N) WALL INFILL, (SEE NOTES & FINISH SCHED.) 3. WRITTEN DIMENSIONS GOVERN. DO NOT SCALE DRAWINGS. 05. (E) WINDOW & FRAME TO BE DEMO, TYP. 25. (N) PIN LETTERING, (SEE SIGNAGE "UNDER SEPARATE PERMIT".). 37. (N) PALM TREE, (SEE NOTES & LANDSCAPE DWGS) 06. (E) PALM TREE TO BE DEMO, TYP. (SEE LANDSCAPE DWGS). 4. ALL PATHWAYS MUST BE 36" WIDE (MIN.) VERIFY. 26. (N) EXTERIOR LIGHT FIXTURE, (SEE LIGHTING DWGS.). 27. (N) FABRIC AWNING WITH LIGHT FIXTURE, (SEE ELEV & LIGHTING DWGS.). 07. (E) CONC. SIDEWALK & PAVERS TO BE DEMO (PARTIAL / WHERE INDICATED), 5. ALL CONCRETE FEATHER WORK DONE AT THRESHOLDS TO MEET CBC STANDARDS PRIOR TO START. PREPARE AREA TO RECEIVE (N) CONC. & PAVERS (WHERE INDICATED). 28. (N) METAL BACK-LITE SIGNAGE, WALL MOUNTED (SEE ELEV. & SIGNAGE. (SEE LANDSCAPE DWGS.). 6. CALCS AND DETAILS FOR MOUNTING HANDRAILS AND CONNECTION OF GUARDRAILS "UNDER SEPARATE PERMIT"). SHALL BE PROVIDED FOR REVIEW AND APPROVAL PRIOR TO INSTALL FOR 08. (E) CONC. CURB TO BE DEMO, (SEE PLAN) COMPLIANCE WITH CBC 3103F.11. 29. (N) BIKE RACK, (SEE LANDSCAPE DWGS) 09. (E) BIKE RACK TO BE REMOVED, RETAIN TO RELOCATE, (SEE LANDSCAPE DWGS.). 7. ALL WALL INFILL TO MATCH (E) ADJACENT CONDITION, (SEE FINISH SCHED.) TYP. 30. (N) METAL GRATE AT PALM TREES SIDEWALK, FLUSH WITH ADJACENT CONC. 10. (E) HANDRAIL TO BE DEMO (SEE PLAN & LANDSCAPE DWGS.). SIDEWALK, SLIP RESISTANT, (SEE PLAN FOR LOCATIONS). 8. FOR PALM TREES LOCATIONS & ADDITIONAL INFO. SEE LANDSCAPE DWGS. 11. (E) DOOR AND FRAME TO REMAIN, PREPARE TO REPAINT, TYP. 31. (N) HANDRAIL, (SEE LANDSCAPE DWGS.). 12. (E) CONC. RAMP TO BE DEMO PREPARE AREA TO RECEIVE (N) CONC., 32. (N) STAIR (SEE LANDSCAPE DWGS.). (SEE LANDSCAPE DWGS.) 13. (E) CORNICE TO BE DEMO (WHERE INDICATED), TYP. 14. (E) SIGNAGE TO BE DEMO, TYP. G D В T. O. PARAPET EXTERIOR BLDG. ELEVATION EAST - DEMO 3/16" = 1'-0" T.O. COL. / PIER 24' - 0"

TYP. P-1 01

TYP. P-1 01

TYP. P-1 24

TYP. P-1 01

TYP. P-3 27

TYP. P-3 26

TYP. P-1 21

P-1 01

Ground Flr Level

2 EXTERIOR BLDG. ELEVATION EAST - PROPOSED 3/16" = 1'-0"

TYP. P-1 01

T. O. PARAPET

T.O. Parapet - 21' - 6 1/2"

T.O. Parapet - 21' - 6 1/2"

Lower Fir Level 1 -1' - 1"

24 P-1 TYP.

27 P-3 TYP.

UPPER 26' - 3 1/2"

RH PALM DESERT **GALLERY**

> 73100 El Paseo, Suites 3-10 Palm Desert CA, 92260 APN 627-192-014

Architect:

Project Title:

Client:

FOUST ARCHITECTURE 4804 Mission St. San Francisco, CA 94114 brian@foustarchitecture.com

T: 857.574.0010

Stamps:



Agency Approvals:

Issue Description PLANNING RE-SUBMITTAL C.G. 08/28/2024 Project No. As Indicated Sheet Title:

EXTERIOR ELEVATIONS

AP4.3

DEMOLITION KEYNOTES:

- 01. EXISTING TO REMAIN.
- 02. (E) CORNICE TO BE DEMO, (SEE ELEVATIONS).
- 03. (E) WALL TO BE DEMO, (SEE ELEV.).
- 04. (E) DOOR TO BE DEMO, (SEE ELEV.).
- 05. (E) WINDOW TO BE DEMO, (SEE ELEV.).
- 06. (E) AWNING TO BE REMOVE AND RETURN TO OWNER, TYP.
- 07. (E) CONC. SIDEWALK TO BE DEMO (PARTIAL), PREPARE AREA TO RECEIVE (N) CONC. (& PAVERS WHERE INDICATED), PATCH TO MATCH (E) CONDITIONS. (SEE PLANS & LANDSCAPE DWGS).

STOREFRONT NORTH - SECTION / ELEVATION - PROPOSED

1/2" = 1'-0"

08. (E) CONC. CURB TO BE DEMO, (SEE ELEV.)

PLAN KEYNOTES:

- 21. EXISTING TO REMAIN
- 22. (N) WALL FACADE, (SEE ELEV)
- 23. (N) WALL CORNICE, TYP.
- 24. (N) (N) WINDOW SYSTEM, (SEE ELEV.)
- 25. (N) METAL AWNING WITH LIGHT FIXTURE, (SEE ELEV. & LIGHTING DWGS)
- 26. (N) METAL BACK-LITE SIGNAGE, (SEE ELEV., LIGHTING & SIGNAGE DWGS)

3 STOREFRONT NORTH - SECTION / ELEVATION - DEMO 1/2" = 1'-0"


- 27. (N) DOOR SYSTEM, (SEE ELEV.).
- 28. (N) HANDRAIL, (SEE LANDSCAPE DWGS).
- 29. (N) LIGHT FIXTURE (SEE LIGHTING DWGS.).
- 30. (N) METAL PLANTERS, (SEE LANDSCAPE DWGS).
- 31. (N) CONC. SLOPED WALKWAY, (SEE LANDSCAPE DWGS.)
- 32. (N) SIDEWALK & PAVERS (WHERE INDICATED, SEE PLAN & LANDSCAPE DWGS.)

FINISH SCHEDULE - EXTERIOR	

	MARK	MANUF.	COLOR	COLOR#	REMARKS
	P-1	PAINT	MARITIME WHITE	OC-5	50% FORMULA - EXTERIOR BUILDING
	P-2	JON NORRIED	RH BRONZE	MODERN MASTER METALLIC SATIN	STORE FRONT & WINDOW FRAMES
\wedge	P-3	JON NORRIED	RH BRONZE	MODERN MASTER METALLIC SATIN	METAL AWNINGS & METAL SIGNAGE
$\frac{1}{2}$	FB-1		HEATHER BEIGE	CUSTOM	CUSTOM FABRIC ON EXTERIOR AWNING

NOTE: FOR EXTERIOR LIGHTING ADD'L. INFO. SEE LIGHTING DWGS. FOR LANDSCAPE ADD'L. INFO. SEE LANDSCAPE DWGS. FOR SIGNAGE, SEE SIGNAGE DWGS, -(UNDER SEPARATE PERMIT).

2 STOREFRONT SOUTH - SECTION / ELEVATION - PROPOSED 1/2" = 1'-0"

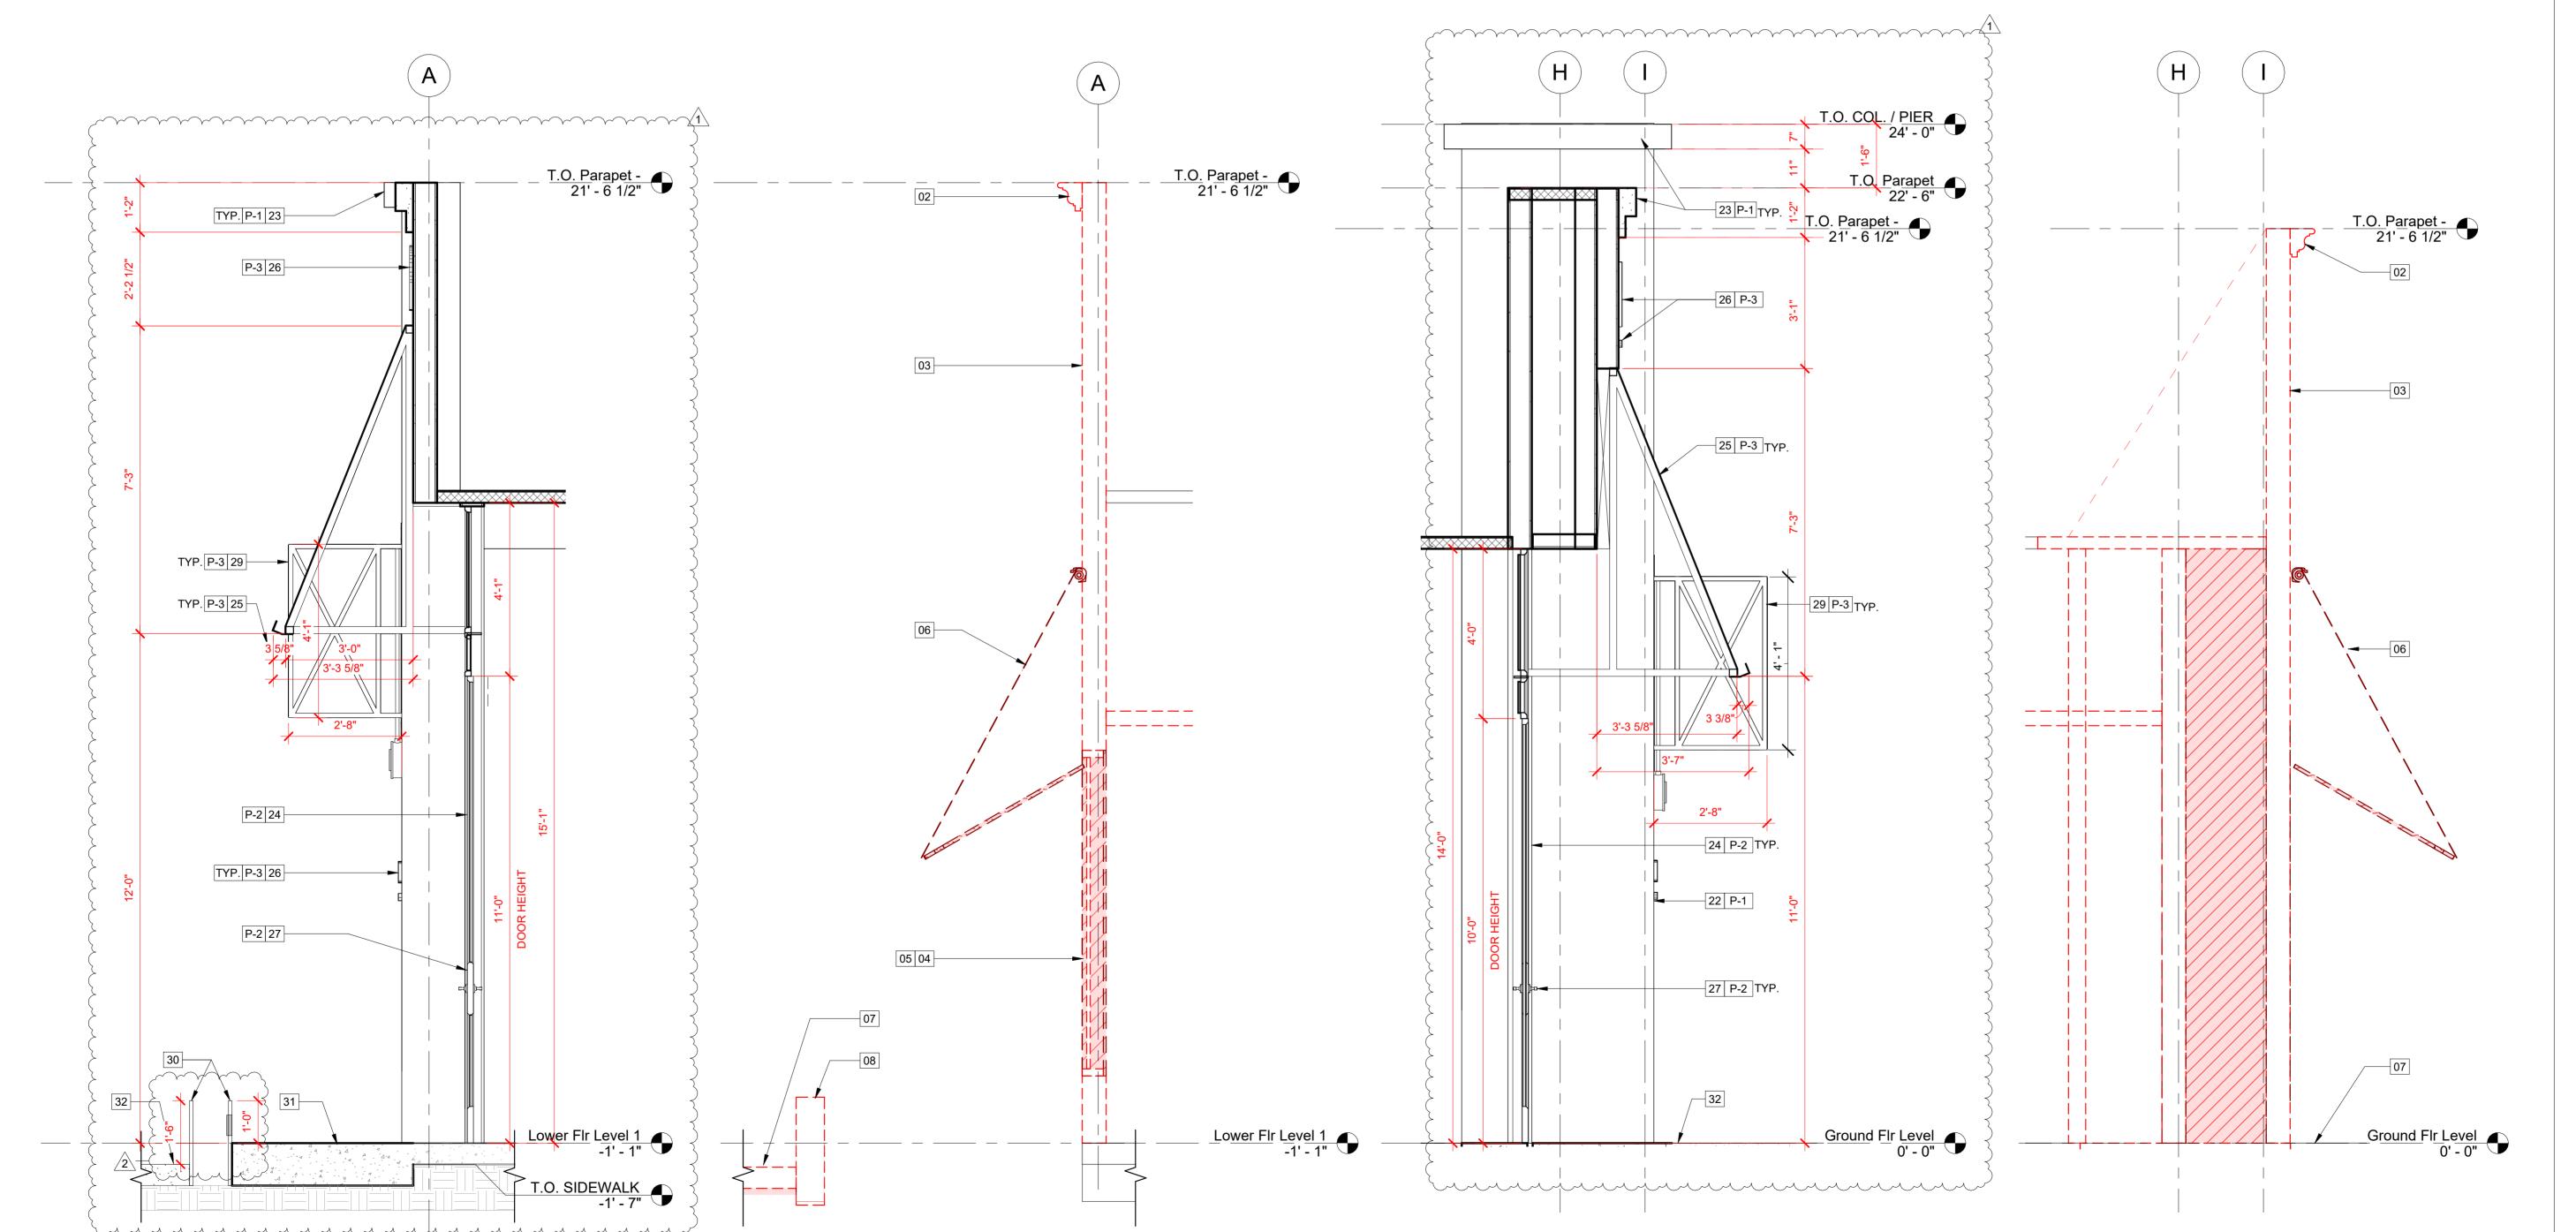

Client:



Project Title:

RH PALM DESERT GALLERY

73100 El Paseo, Suites 3-10 Palm Desert CA, 92260 APN 627-192-014

Architect:



FOUST ARCHITECTURE
4804 Mission St.
San Francisco, CA 94114
brian@foustarchitecture.com
T: 857.574.0010

Stamps:



Agency Approvals:

	I D WINNING CODIVITIONE		12/20/202
1	PLANNING RE-SUBMITTAL		01/31/2025
2	PLANNING RE-SUBMITTAL 2		02/05/2025
Auth	or:		
			C.G
Date			
		30	3/28/202
Proje	ect No.		
,			240

Issue Description

STOREFRONT SECTION / ELEVATION

Sheet Title:

STOREFRONT SOUTH - SECTION / ELEVATION - DEMO

1/2" = 1'-0"

AP4.4

As Indicated







FRONT ELEVATIONS - EXISTING



FINISH SCHEDULE - EXTERIOR				
MARK	MANUF.	COLOR	COLOR#	REMARKS
P-1	PAINT	MARITIME WHITE	OC-5	50% FORMULA - EXTERIOR BUILDING
P-2	JON NORRIED	RH BRONZE	MODERN MASTER METALLIC SATIN	STORE FRONT & WINDOW FRAMES
P-3	JON NORRIED	RH BRONZE	MODERN MASTER METALLIC SATIN	METAL AWNINGS & METAL SIGNAGE
FB-1	~ ~ ~ ~ ~ ~ ~ ~ ~	HEATHER BEIGE	CUSTOM	CUSTOM FABRIC ON EXTERIOR AWNING

NOTE: FOR EXTERIOR LIGHTING ADD'L. INFO. SEE LIGHTING DWGS. FOR LANDSCAPE ADD'L. INFO. SEE LANDSCAPE DWGS.

FRONT ELEVATIONS - PROPOSED



WEST SIDE ELEVATION - EXISTING





REAR ELEVATION - EXISTING



REAR ELEVATION - PROPOSED

Client:



Project Title:

RH PALM DESERT GALLERY

73100 El Paseo, Suites 3-10 Palm Desert CA, 92260 APN 627-192-014

Architect:



FOUST ARCHITECTURE 4804 Mission St. San Francisco, CA 94114 brian@foustarchitecture.com T: 857.574.0010




Agency Approvals:

No	Issue Description	Date
	PLANNING SUBMITTAL	12/20/2024
1	PLANNING RE-SUBMITTAL	01/31/2025
2	PLANNING RE-SUBMITTAL 2	02/05/2025
Author	:	
		C.G.

08/28/2024 Project No. As Indicated

EXTERIOR BLDG. SITE PHOTOS & RENDERINGS -**EXISTING & PROPOSED**

AP4.5

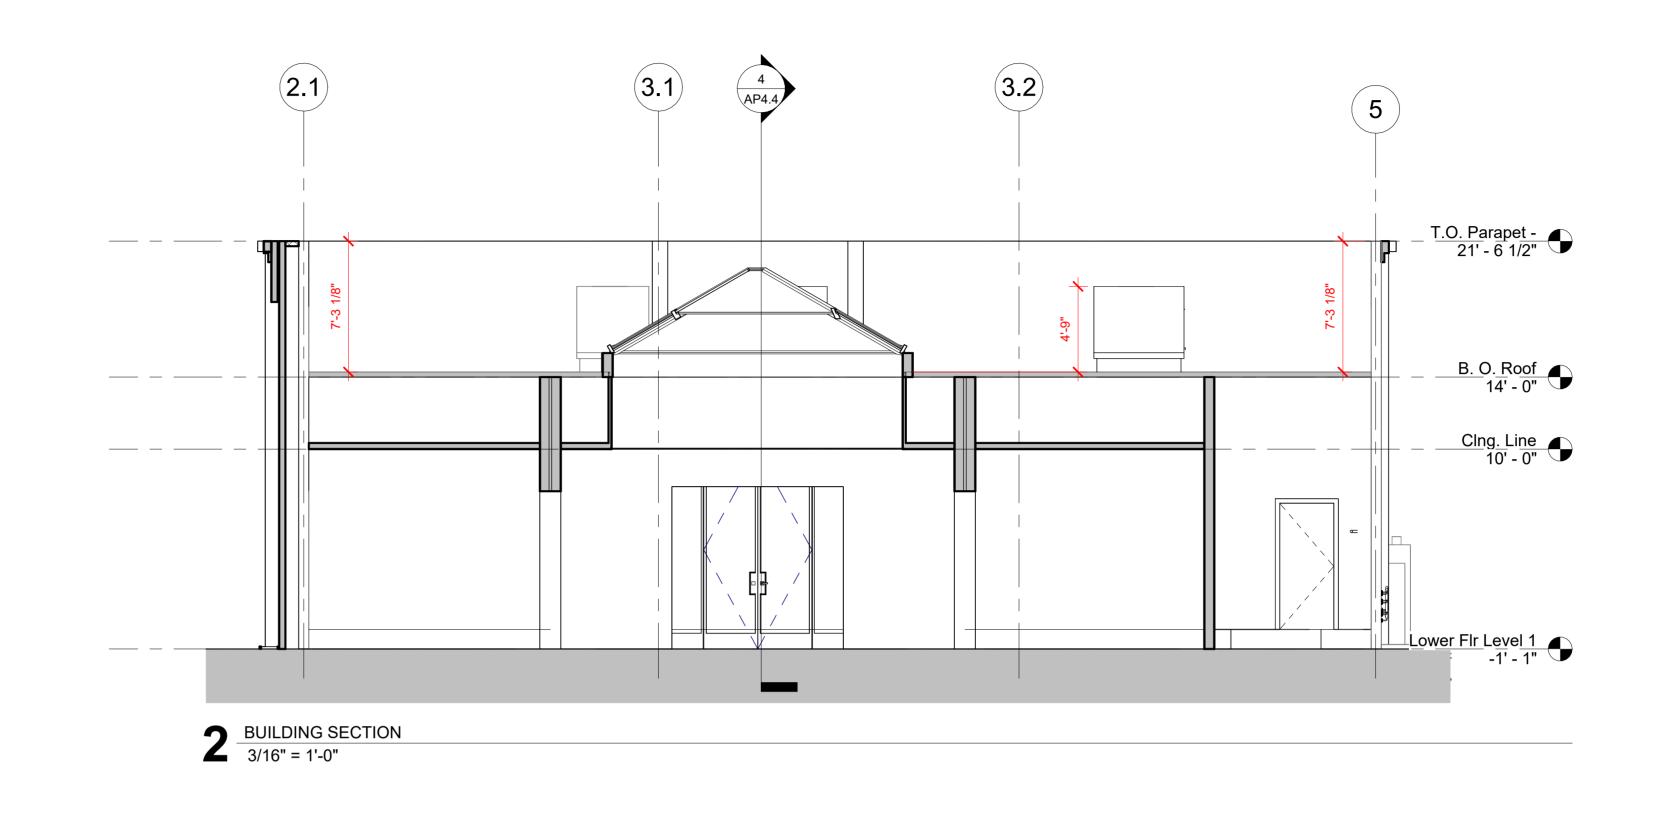

Client:



Project Title:

RH PALM DESERT GALLERY

73100 El Paseo, Suites 3-10 Palm Desert CA, 92260 APN 627-192-014


Architect:



Stamps:




Agency Approvals:

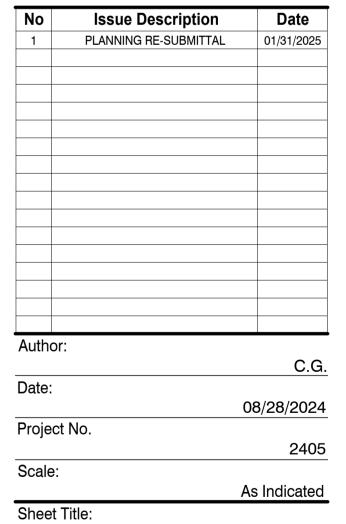


BUILDING SECTION



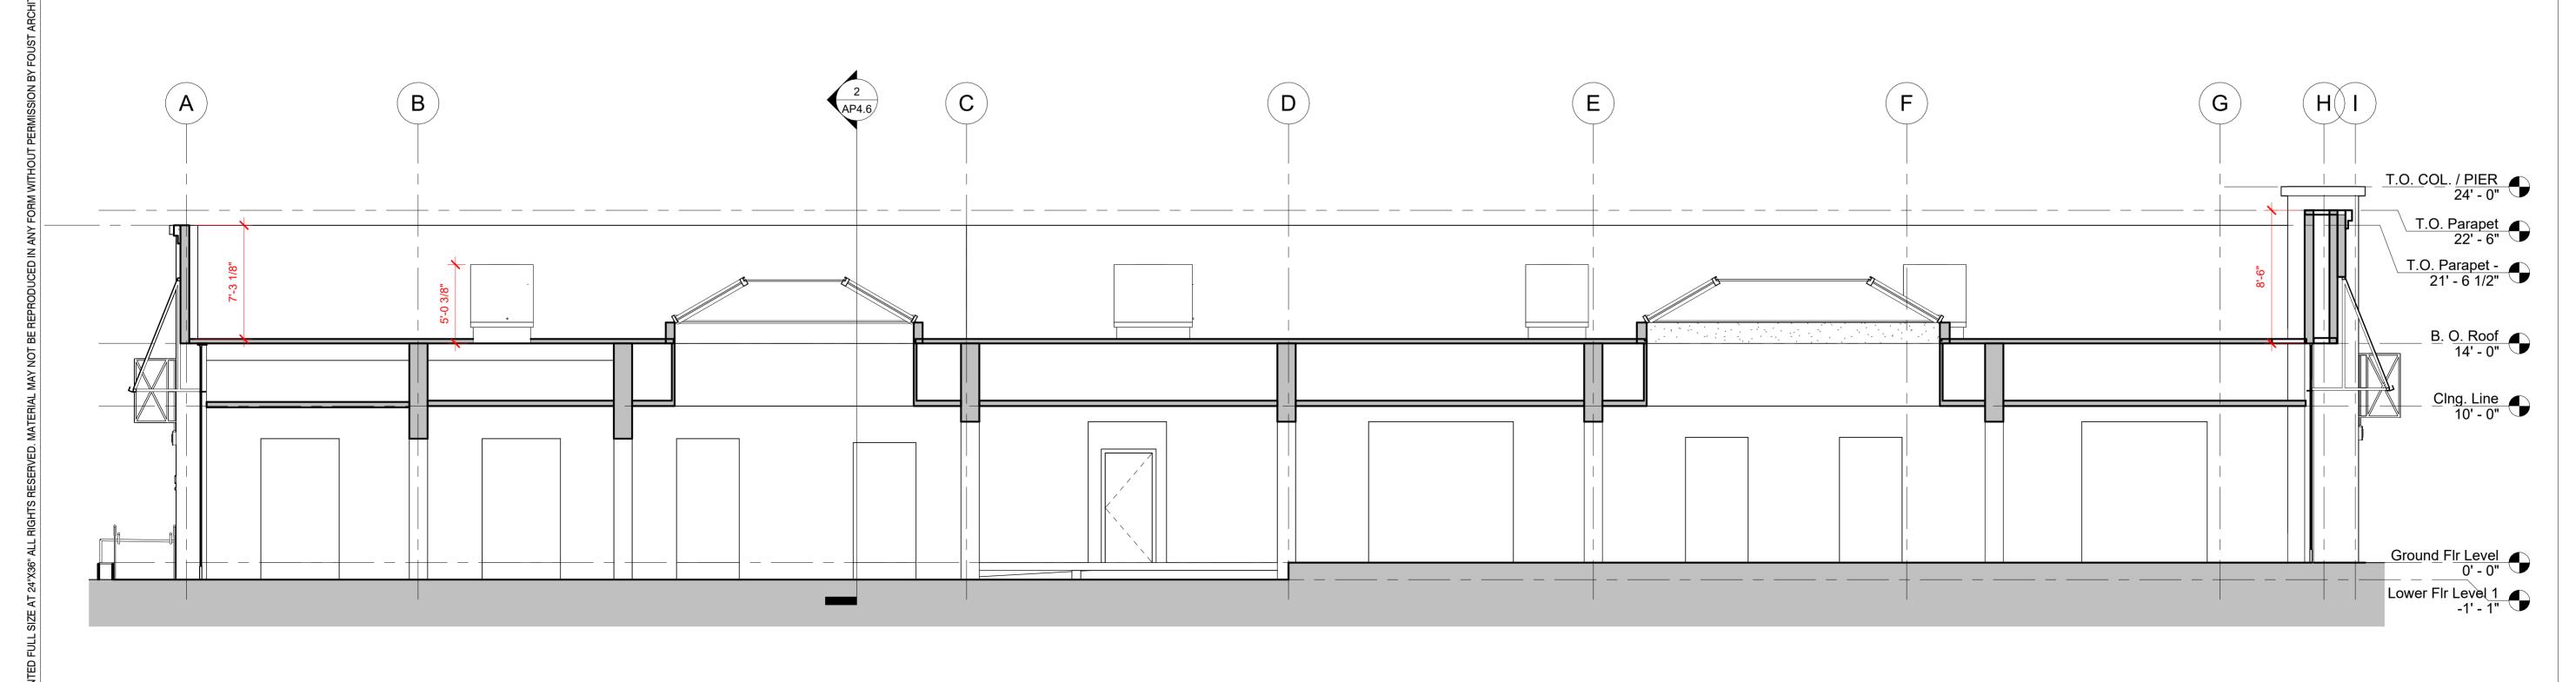

BUILDING SECTION

3/16" = 1'-0"

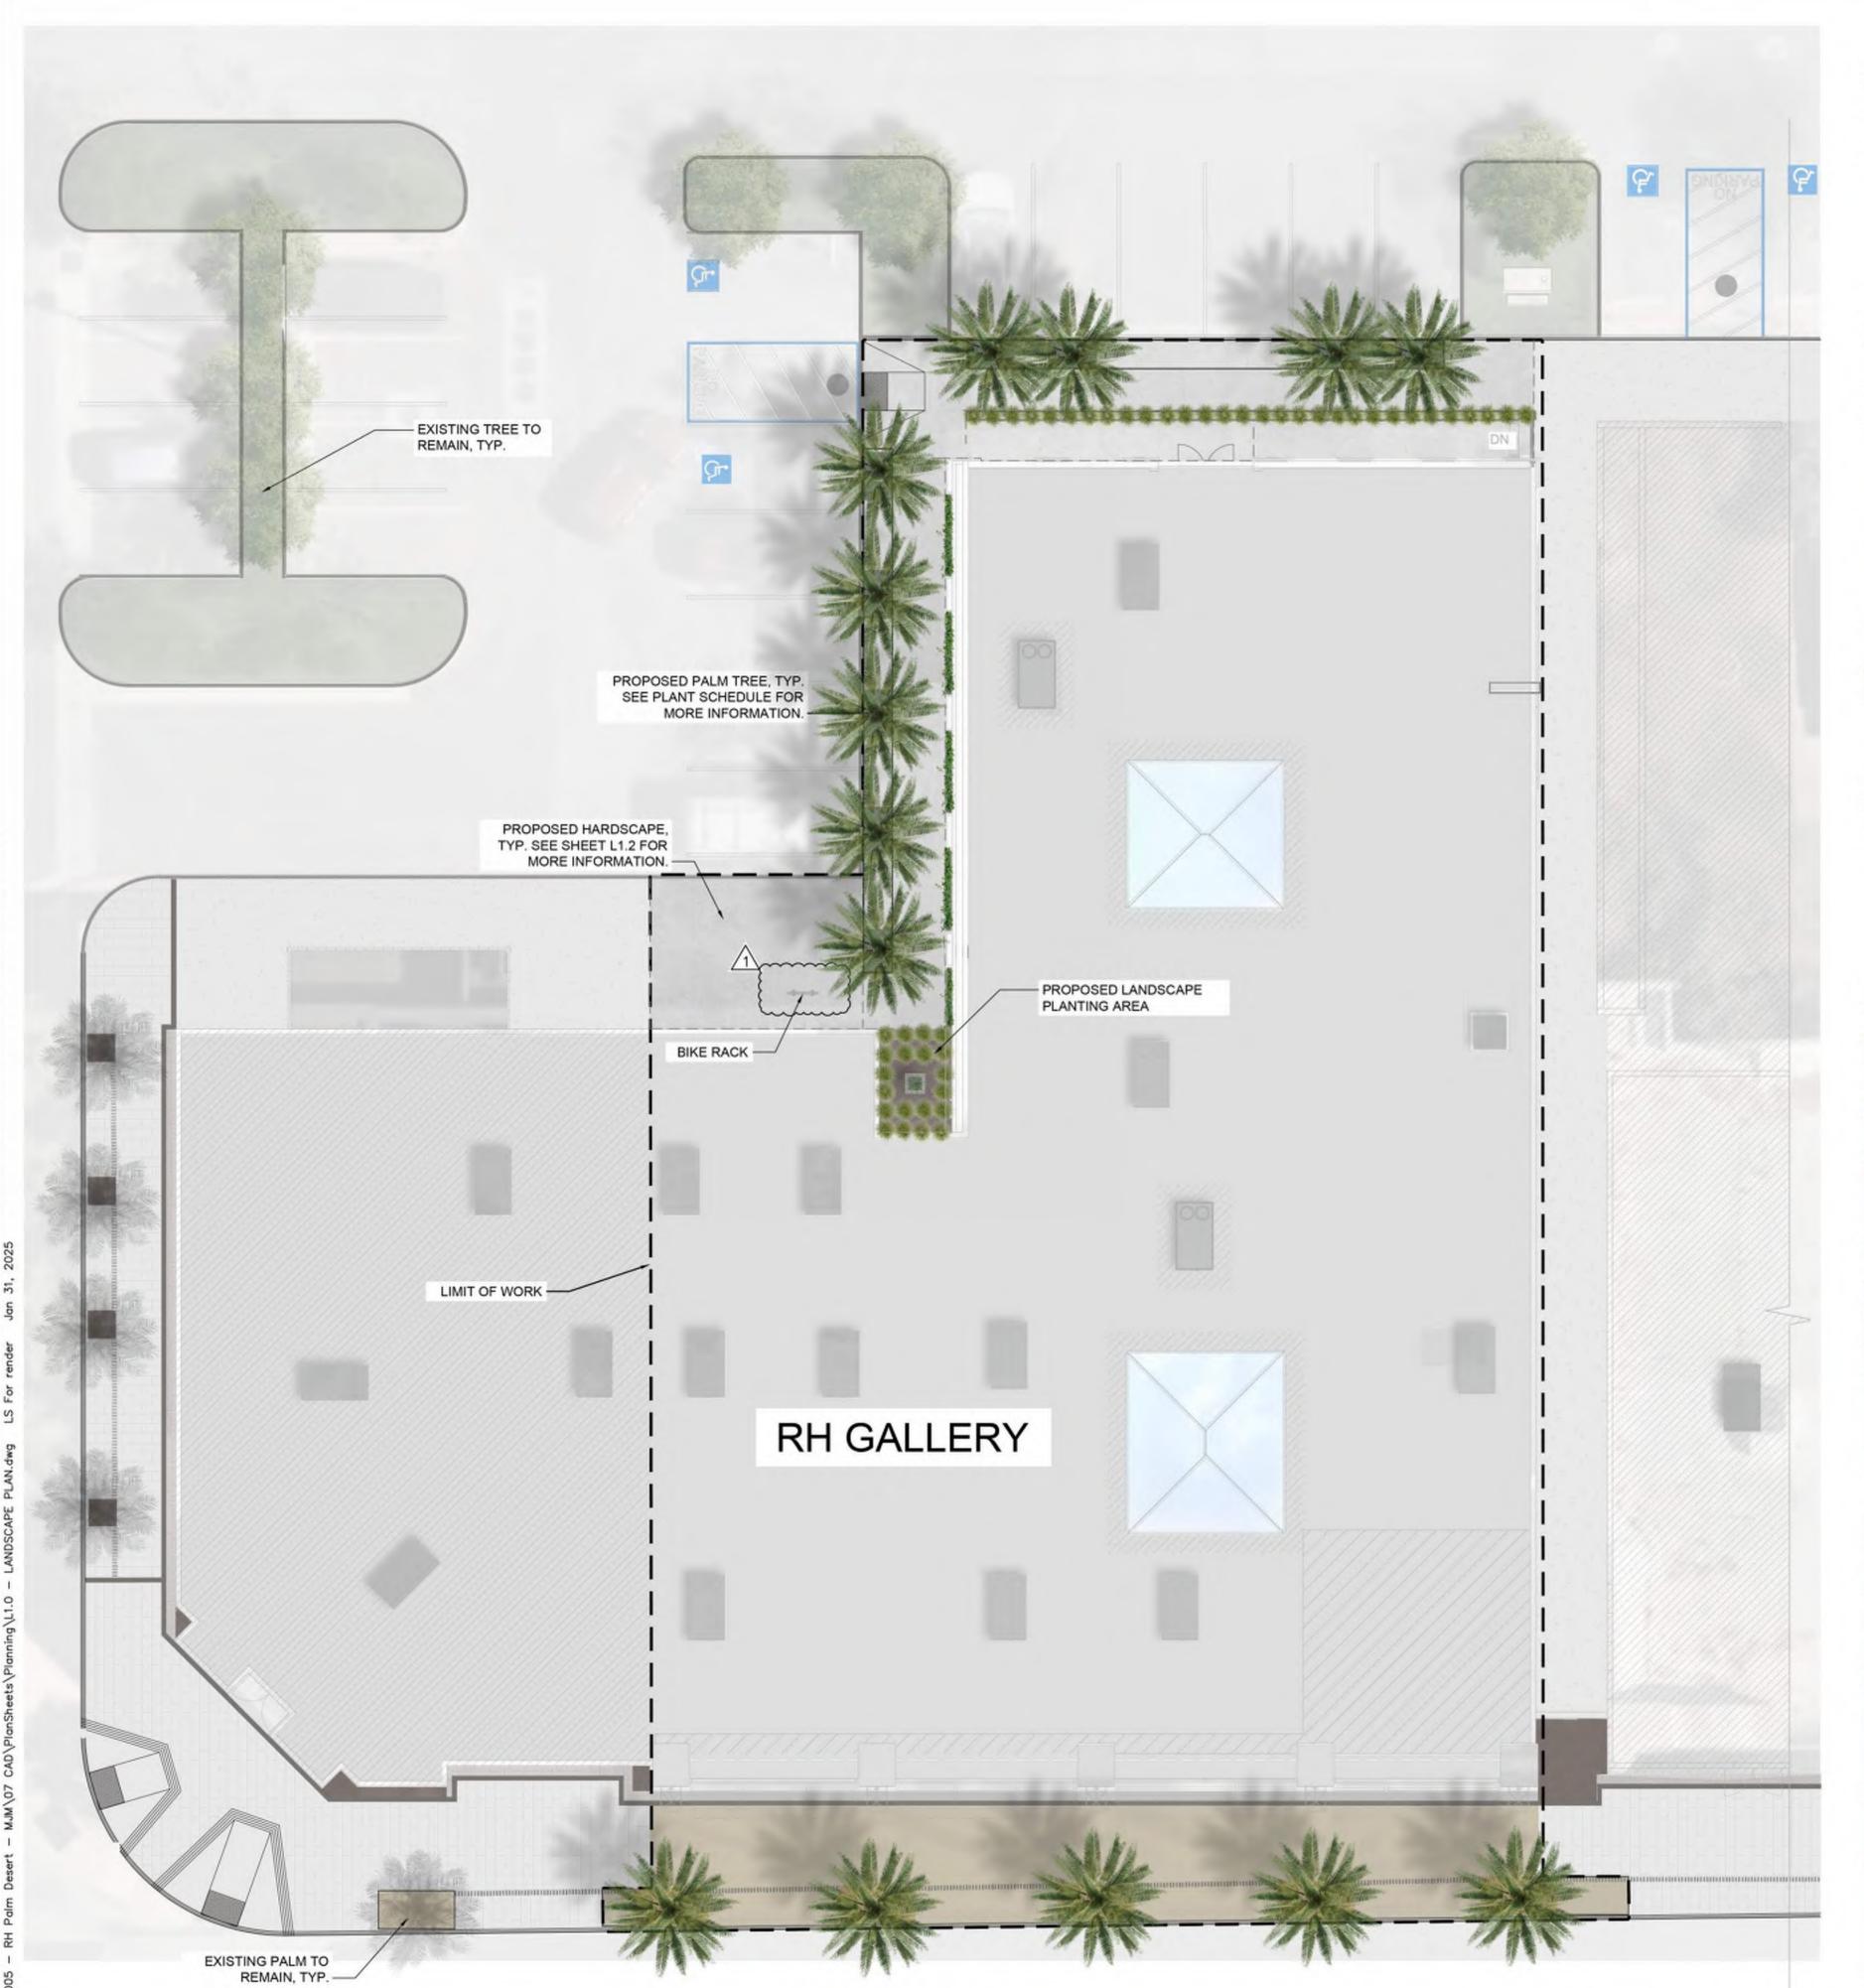

EL PASEO

PRELIMINARY LANDSCAPE LEGEND

SYMBOL	QTY	BOTANICAL / COMMON NAME	CONT	WUCOLS	SIZE AT MATURITY
TREES					
*	5	EXISTING TO REMAIN / PROTECT IN PLACE	N/A	N/A	N/A
-	6	EXISTING TO REMAIN / PROTECT IN PLACE	N/A	N/A	N/A
業	14	PHOENIX DACTYLIFERA 'MEDJOOL' / MEDJOOL DATE PALM	20° B.T.H. MIN.	MODERATE	20' HT. X 15-25' SPR.
SYMBOL	QTY	BOTANICAL / COMMON NAME	CONT.	WUCOLS	MATURE SIZE
SHRUBS					
**	1	AGAVE AMERICANA / CENTURY PLANT	5 GAL.	LOW	3-4' HT. X 3-4' SPR.
*	49	LOMANDRA CONFERTIFOLIA 'LIMTIGRA' / LEADING® LIME TIGHT™ MAT RUSH	5 GAL.	LOW	1-2' HT. X 1-2' SPR.
VINES					
Audiotobiopoia	9	FICUS PUMILA / CREEPING FIG	5 GAL.	MODERATE	8-15' HT. X 3-6' SPR.
SYMBOL	QTY	BOTANICAL / COMMON NAME			
GROUND	COVERS				
	1,571 SF	EXISTING LANDSCAPE TO REMAIN / PROTECT I N PLACE			

METHODS OF IRRIGATION

ALL SHRUBS WILL BE IRRIGATED BY LOW FLOW SUBSURFACE DRIP IRRIGATION. ALL PALMS WILL BE IRRIGATED BY DRIP RINGS.


PLANT IMAGERY




LOMANDRA CONFERTIFOLIA 'LIMTIGRA'



PHOENIX DACTYLIFERA 'MEDJOOL'

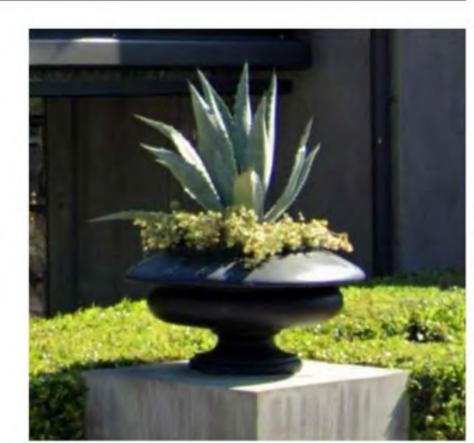

AGAVE AMERICANA

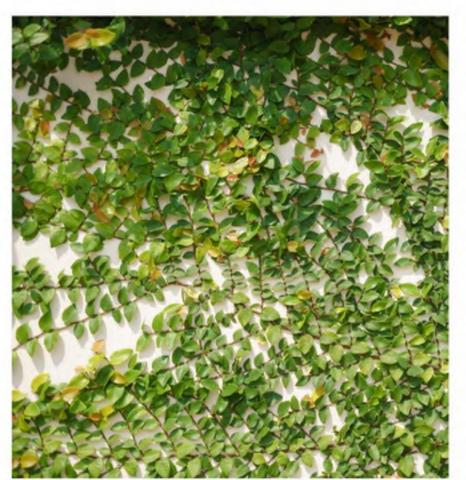

FICUS PUMILA



73100 EL PASEO STE 4, PALM DESERT CA, 92260

RH PALM DESERT


Kimley»Horn

KIMLEY-HORN & ASSOCIATES 10 S. Almaden Blvd, Suite 1250 San Jose, CA 95113 T: 669.800.4130



No.	Issue		Date
Δ	PLAN	NING REVISION	1/31/202
Date	1/31,	/2025	
		1/31/2025	
		197432005	
Scal	е	As Indicated	
Shor	et Title		

L1.1

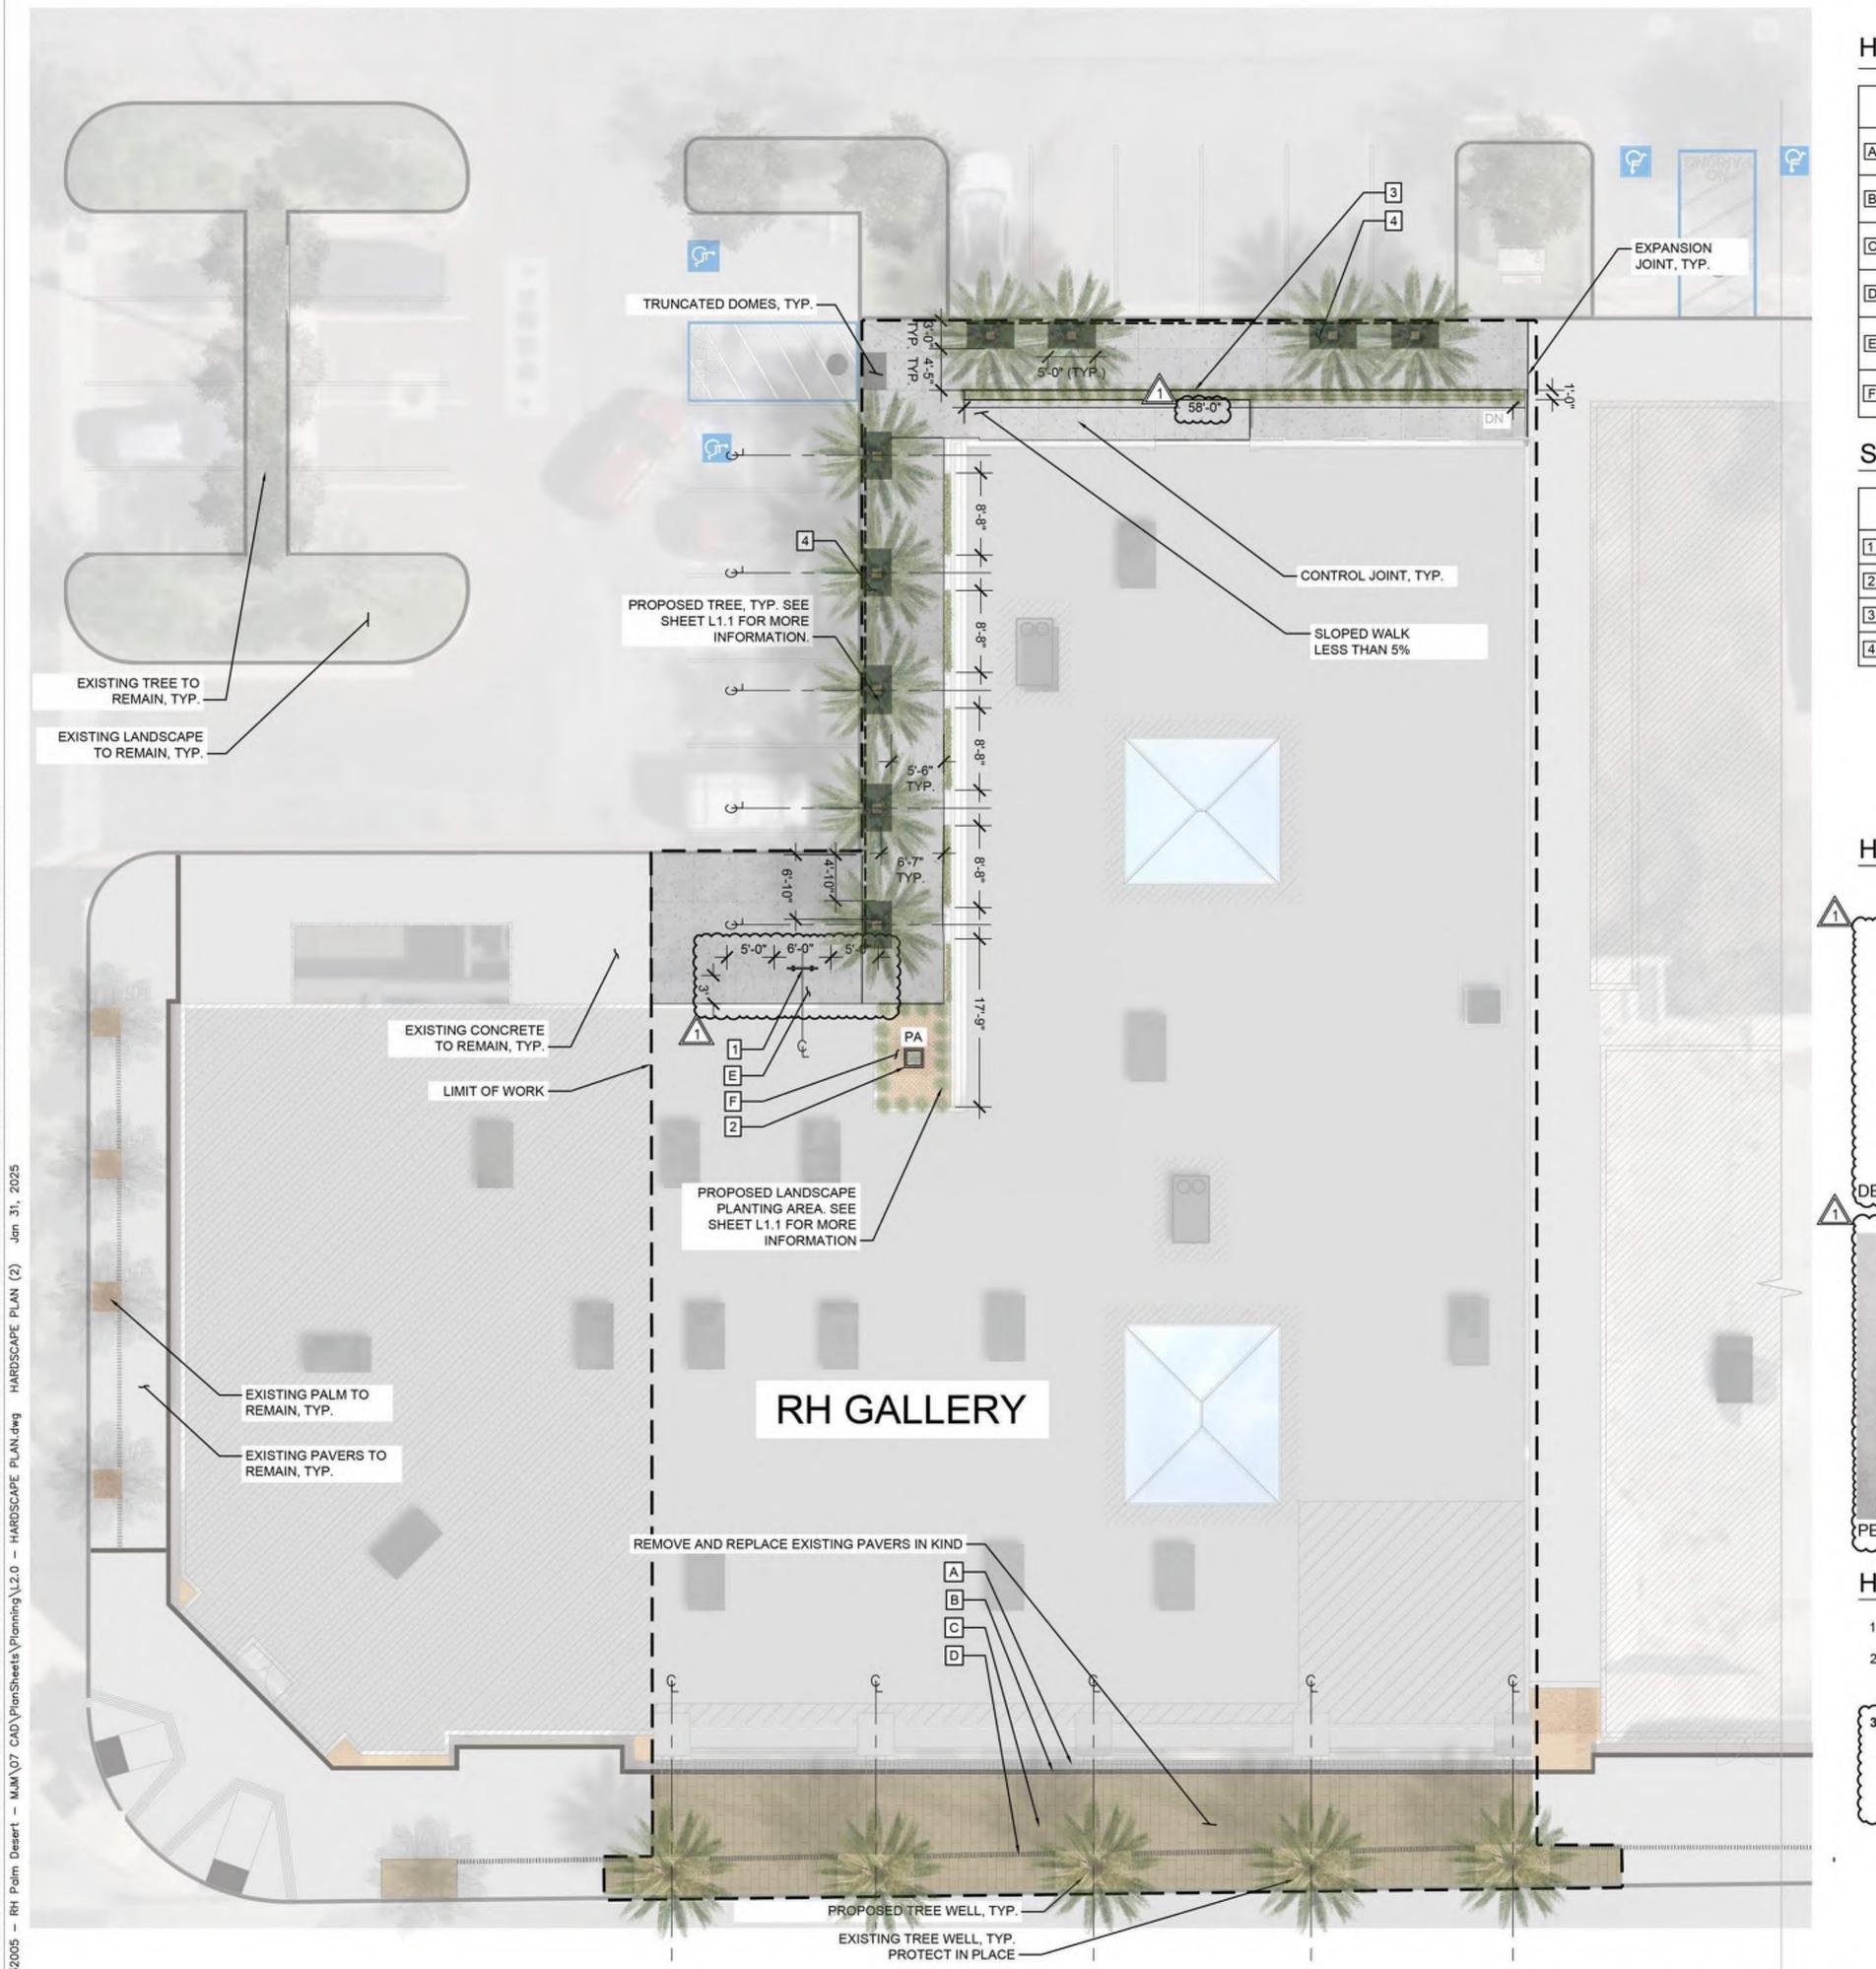

EL PASEO

HARDSCAPE LEGEND

	REF.#	DESCRIPTION
Α		ENHANCED PAVEMENT PAVER A
В		ENHANCED PAVEMENT PAVER B
C		ENHANCED PAVEMENT PAVER C
D		ENHANCED PAVEMENT PAVER D
E		PEDESTRIAN CONCRETE
F		DECOMPOSED GRANITE

SITE FURNISHINGS LEGEND

REF.#	DESCRIPTION	
1 +	BIKE RACK	
2	DECORATIVE PLANTER (CLIENT FURNISHED)	
3	METAL EDGE PLANTER	
4	TREE GRATE	

HARDSCAPE IMAGERY



- 1. SEE LIGHTING PLANS FOR EXTERIOR LIGHT FIXTURE LOCATIONS.
- 2. APPLICANT PROPOSES TO RELOCATE FOUR OF THE FIVE EXISTING STREET TREE WELLS ALONG EL PASEO BLVD LOCATIONS.
- SIDEWALK, THE MANEUVERING AREA MAY EXTEND INTO THE RIGHT-OF-WAY. THE AREA DEVOTED TO BICYCLE PARKING





73100 EL PASEO STE 4, PALM DESERT CA, 92260

Kimley » Horn

KIMLEY-HORN & ASSOCIATES 10 S. Almaden Blvd, Suite 1250 San Jose, CA 95113 T: 669.800.4130



No.	Issue	Date
Δ	PLANNING REVISION	1/31/202


Date 1/31/2025 Issue Date 1/31/2025


Project No. 197432005

Scale As Indicated


Sheet Title

PRELIMINARY HARDSCAPE PLAN

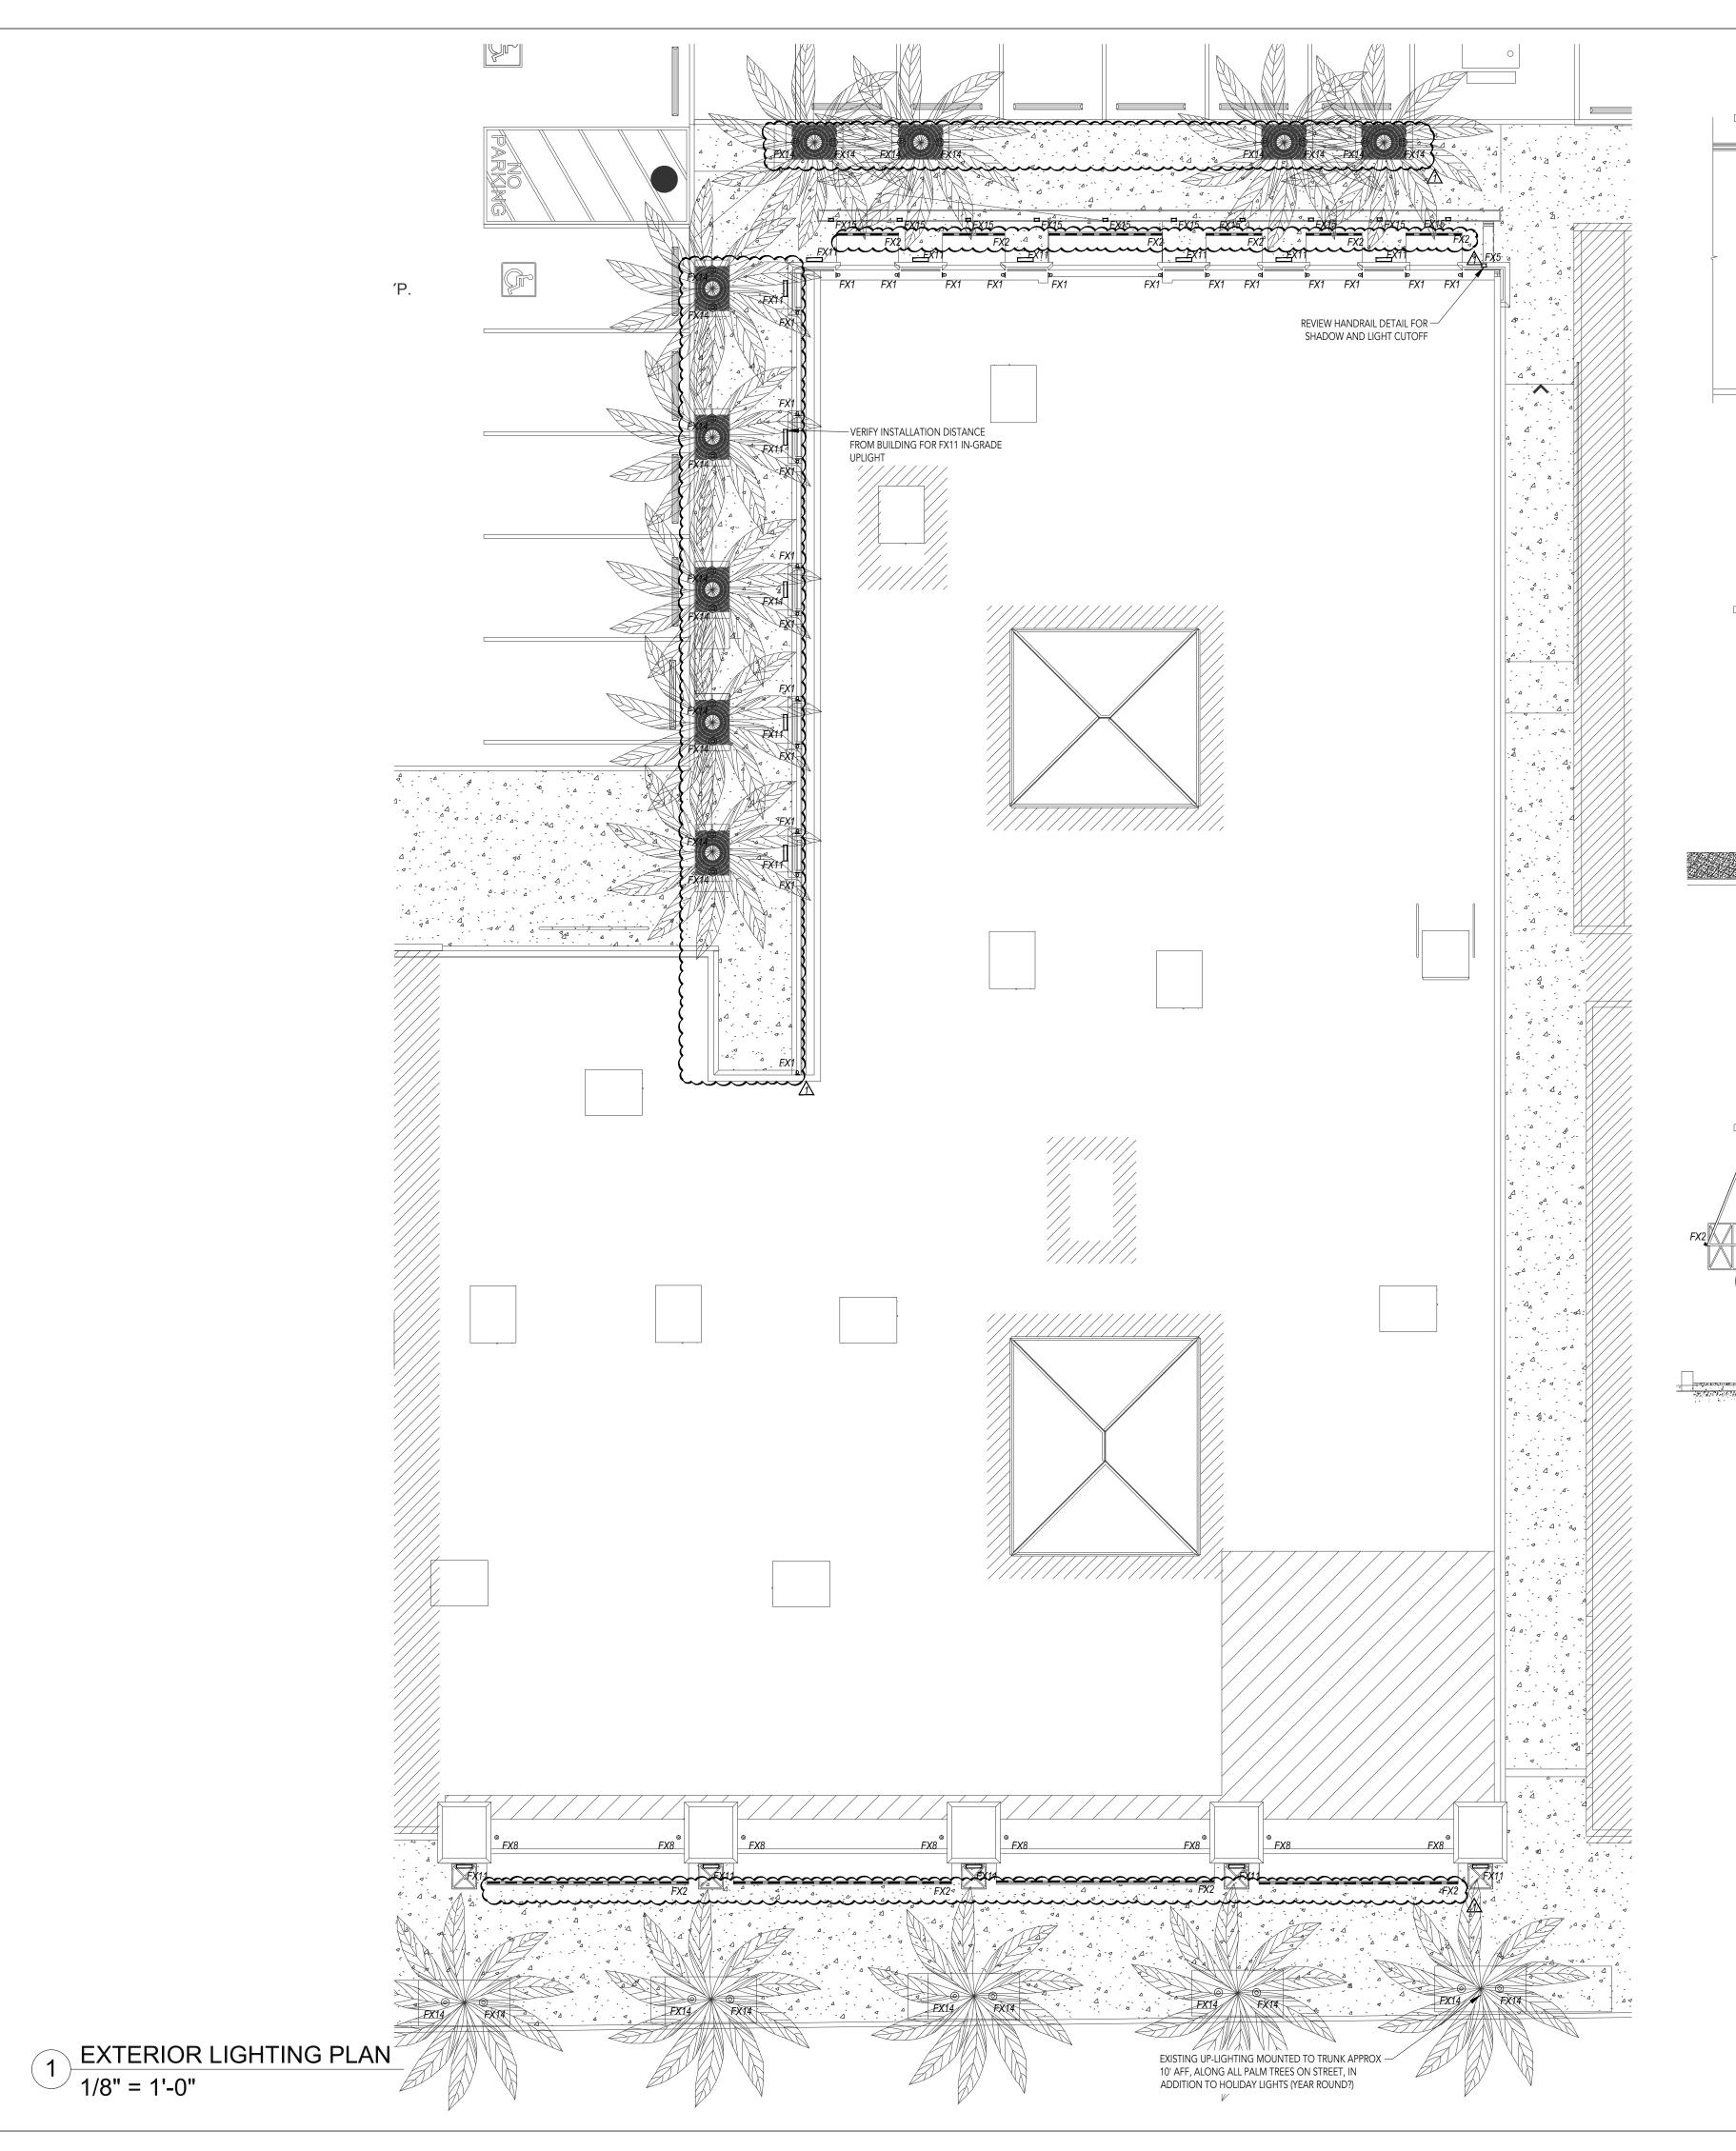


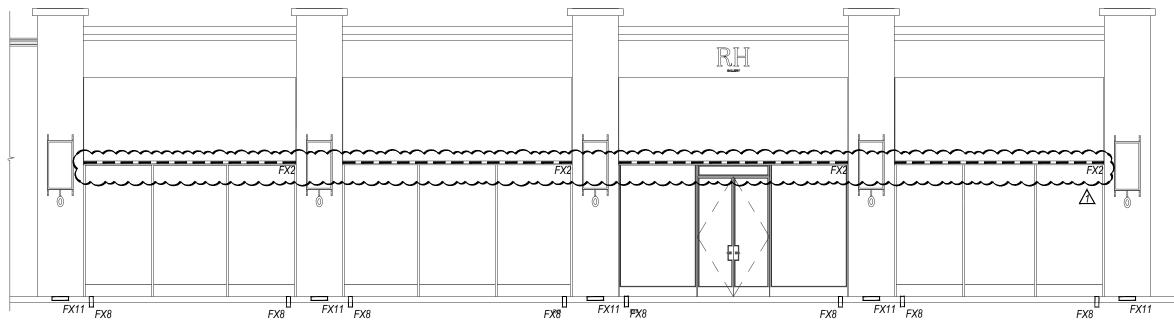

2 SOUTH ELEVATION: EL PASEO 1/8" = 1'-0"

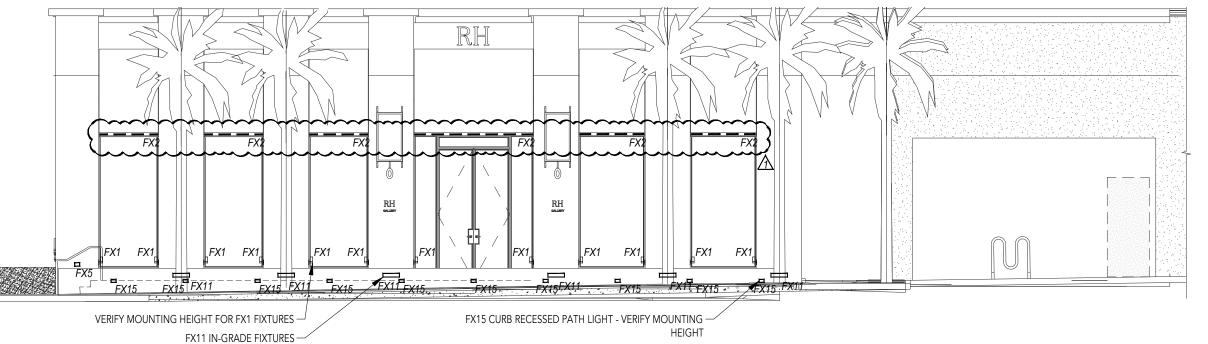

3 NORTH ELEVATION: REAR ENTRANCE 1/8" = 1'-0"

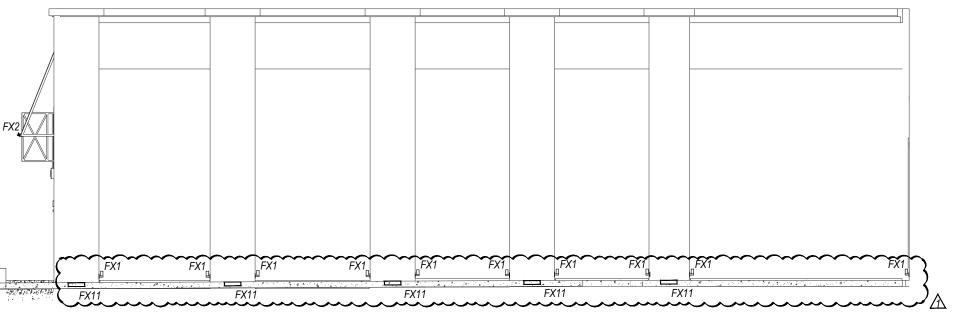

WEST ELEVATION: EL PASEO DR.

1/8" = 1'-0"

LIGHTING CONTROL SYSTEM SEQUENCE OF OPERATION:

ALL INTERIOR AND EXTERIOR BUILDING LIGHTING AT RHPALM DESERT GALLERY IS CONTROLLED BY PRESET SCENES ON A TIME CLOCK SCHEDULE.

BUILDING WIDE SCENE DESCRIPTIONS

SCENE 1: RETAIL DAY ACTIVATES AT 7:00AM DAILY, 15 SECOND FADE TIME. EXTERIOR LIGHTING TURNS OFF

SCENE 2: RETAIL NIGHT ACTIVATES 15 MINUTES BEFORE SUNSET, 15 SECOND FADE TIME. EXTERIOR LIGHTING TURNS ON AT PRESET, DIMMED LEVELS DETERMINED BY LIGHTING DESIGNER AND APPROVED BY RH.

NOTES FOR ZONING AND LIGHTING CONTROLS:

ALL EXTERIOR LIGHTING TO BE DIMMABLE, INCLUDING ARCHITECTURAL AND DECORATIVE (MERCHANDISE) LIGHTING.
 ONE ZONE PER "F" TYPE, PER INSTALLATION LOCATION OR CONDITION (UNLESS OTHERWISE NOTED ON DRAWINGS).

GENERAL NOTE:

1. ARCHITECT TO REVIEW DRAWINGS AND ADVISE OF CONFLICTS BETWEEN LIGHTING AND ACCESS PANELS, SPEAKER AND SPRINKLERS ETC. LIGHTING LOCATION SHOULD TAKE PRIORITY.

LIGHTING LEGEND				
TYPE	SYMBOL	DESCRIPTION	LOCATION	
FX1	đ	JAMB MOUNTED ACCENT LIGHT	REAR FACADE DOOR AND WINDOW JAMBS	
FX2		SURFACE MOUNTED LINEAR LED LIGHT	FACADE AWNINGS	
FX5	=	WALL MOUNTED WALL WASHER	REAR FACADE PILASTER	
FX8	0	GRADE RECESSED ACCENT LIGHT	FACADE WINDOW JAMBS	
FX11		GRADE RECESSED WALL WASHER	FACADE PILASTERS	
FX14	©	GRADE RECESSED LANDSCAPE ACCENT LIGHT	PALM TREES	
FX15	_	CURB RECESSED PATH LIGHT	REAR ENTRANCE - CURB	

rkv DESIGN

23823 MALIBU ROAD SUITE 50 - 212 MALIBU, CA 90265

www.rkv-design.com +1 310 924 2185

NOTES FOR GENERAL CONTRACTOR:

 General Contractor (GC) and Electrical Contractor (EC) will be responsible for verification of all dimensions, specifications and coordination with related trades and subcontractors.

2. GC to paint downlight trims to match ceiling per architects direction. Ensure trims can be removed after painting and do not stick.3. GC to furnish and install adequare drainage around all direct burial transformers and

recessed in-grade light fixtures.

4. GC to notify designer of any conflict with mechanical, electrical, plumbing, HVAC or structural presence or any conflicting dimensions or site conditions prior to

commencement of work.
5. GC is responsible for notifying designer of any inconsistencies between design drawings and other documents.
6. Do not scale drawings.

GENERAL NOTES:

1. Lighting Design drawings and dimensions are for design intent only. Coordination with Architectural Drawings required.

2. Fixture types and specifications available in accompanying Specification packet.

3. Calculations for code compliance to be provided by Electrical Engineer.

4. Emergency lighting requirements to be completed by Electrical Engineer.

REV. DATE. DESCRIPTION

11.06.2024 FOR REVIEW
11.20.2024 CHECK SET
12.06.2024 PLANNING SUBMITTAL
12.20.2024 REVISION
01.31.2025 PLANNING RESUBMITTAL

PROJECT:

RH PALM DESERT GALLERY

73100 EL PASEO DRIVE, PALM DESERT, CA 92260

DRAWING TITLE:

EXTERIOR LIGHTING PLAN

LT-1.0